

Proposed Wind Farm Development Seven Hills Wind Farm, Co. Roscommon Planning Permission Application Drawings






Schedule of Drawings


Drawing No.	Drawing Title	Scale
190907 - 01	Location Context Map	1: 50,000 @A3
190907 - 02	Site Location Map	1: 50,000 @A3
190907 – 02a	Site Notice Location Map A	1:5,000 @A3
190907 – 02b	Site Notice Location Map B	1:5,000 @A3
190907 – 02c	Site Notice Location Map C	1:5,000 @A3
190907 – 02d	Site Notice Location Map D	1:5,000 @A3
190907 – 02e	Site Notice Location Map E	1:5,000 @A3
190907 – 02f 190907 – 02g	Site Notice Location Map F Site Notice Location Map G	1:5,000 @A3 1:5,000 @A3
190907 – 02g 190907 – 02h	Site Notice Location Map G Site Notice Location Map H	1:5,000 @A3
190907 – 02i	Site Notice Location Map I	1:5,000 @A3
190907 – 02j	Site Notice Location Map J	1:5,000 @A3
190907 – 02k	Site Notice Location Map K	1:5,000 @A3
190907 - 03	Site Layout Key Plan (1:5,000)	1: 25,000 @A1
190907 - 04	Site Layout Sheet 1 of 6	1: 5,000 @A1
190907 - 05	Site Layout Sheet 2 of 6	1: 5,000 @A1
190907 - 06	Site Layout Sheet 3 of 6	1: 5,000@A1
190907 - 07	Site Layout Sheet 4 of 6	1: 5,000@A1
190907 - 08	Site Layout Sheet 5 of 6	1: 5,000@A1
190907 - 09	Site Layout Sheet 6 of 6	1: 5,000@A1
190907 - 10	Site Layout Key Plan (1:2,500)	1: 25,000@A1
190907 - 11	Site Layout Sheet 1 of 18	1: 2,500@A1
190907 – 12 190907 – 13	Site Layout Sheet 2 of 18 Site Layout Sheet 3 of 18	1: 2,500@A1 1: 2,500@A1
190907 - 13	Site Layout Sheet 3 of 18 Site Layout Sheet 4 of 18	1: 2,500@A1
190907 - 15	Site Layout Sheet 5 of 18	1: 2,500@A1
190907 - 16	Site Layout Sheet 6 of 18	1: 2,500@A1
190907 - 17	Site Layout Sheet 7 of 18	1: 2,500@A1
190907 - 18	Site Layout Sheet 8 of 18	1: 2,500@A1
190907 - 19	Site Layout Sheet 9 of 18	1: 2,500@A1
190907 - 20	Site Layout Sheet 10 of 18	1: 2,500@A1
190907 - 21	Site Layout Sheet 11 of 18	1: 2,500@A1
190907 - 22	Site Layout Sheet 12 of 18	1: 2,500@A1
190907 - 23	Site Layout Sheet 13 of 18	1: 2,500@A1
190907 - 24	Site Layout Sheet 14 of 18	1: 2,500@A1
190907 - 25	Site Layout Sheet 15 of 18	1: 2,500@A1
190907 - 26	Site Layout Sheet 16 of 18 Site Layout Sheet 17 of 18	1: 2,500@A1
190907 – 27 190907 – 28	Site Layout Sheet 17 of 18 Site Layout Sheet 18 of 18	1: 2,500@A1 1: 2,500@A1
190907 - 29	Turbine 1 Layout	1: 500 @A3
190907 - 30	Turbine 2 Layout	1: 500@A3
190907 - 31	Turbine 3 Layout	1: 500@A3
190907 - 32	Turbine 4 Layout	1: 500@A3
190907 - 33	Turbine 5 Layout	1: 500@A3
190907 - 34	Turbine 6 Layout	1: 500@A3
190907 - 35	Turbine 7 Layout	1: 500@A3
190907 - 36	Turbine 8 Layout	1: 500@A3
190907 – 37	Turbine 9 Layout	1: 500@A3
190907 - 38	Turbine 10 Layout	1: 500@A3
190907 - 39	Turbine 11 Layout	1: 500@A3
190907 - 40	Turbine 12 Layout	1: 500@A3
<u>190907 - 41</u>	Turbine 13 Layout	1: 500@A3
190907 - 42 190907 - 43	Turbine 14 Layout Turbine 15 Layout	1: 500@A3 1: 500@A3
190907 - 43	Turbine 16 Layout	1: 500@A3
190907 - 45	Turbine 17 Layout	1: 500@A3
190907 - 46	Turbine 18 Layout	1: 500@A3
190907 - 47	Turbine 19 Layout	1: 500@A3
190907 - 48	Turbine 20 Layout	1: 500@A3
190907 - 49	Turbine 1, 2 & 3 Spoil Storage Sections	1: 200@A3
190907 - 50	Turbine 4, 5, & 6 Spoil Storage Sections	1: 200@A3
190907 - 51	Turbine 7, 8, & 10 Spoil Storage Sections	1: 200@A3
190907 - 52	Turbine 11, 13, & 14 Spoil Storage Sections	1: 200@A3
190907 - 53	Turbine 17, 19, & 20 Spoil Storage Sections	1: 200@A3
190907 - 54	Wind Turbine Elevations and Plan	1:500 @ A1
21337-MWP-ZZ-00-DR-C-0104		1:10, 1:25, 1:100 @A1
SVH_PAS_ECS_001	Anemometer Mast Elevations	1:200, 1:100, 1:50 @A1
21337-MWP-ZZ-00-DR-C-1400		As Shown @A1
21337-MWP-ZZ-00-DR-C-1401	Spoil Storage Sections - South – Sheet 1	As Shown @A1





21337-MWP-ZZ-00-DR-C-5001	Site Internal Ducting - Cable trench and Crossing details	1:10 @A1
60634578-ACM-DR-CE-001	110kV Substation Proposed Layout	NTS @A1
60634578-ACM-DR-CE-002	110kV Substation Site Elevations	NTS @A1
60634578-ACM-DR-CE-005	Indicative Drainage Layout	NTS @A1
21337-MWP-ZZ-00-DR-C-0103	Temporary Construction Compound 1 &2	NTS @A1
60634578-ACM-DR-CE-006	110kV Typical Connection Bay	1:100 @ A1
60634578-ACM-DR-CE-036	110kV Typical Standard Trench Detail	NTS @ A1
60634578-ACM-DR-CE-037	110kV Typical Joint Box Detail	NTS @A1
60634578-ACM-DR-CE-041	WC1 - Ballyglass River/Culvert Crossing	As shown @A0
60634578-ACM-DR-CE-042	WC2 – HDD of Cross River	As shown @A0
60634578-ACM-DR-CE-043	WC3 – Culvert Crossing	As shown @A0
60634578-ACM-DR-CE-044	WC5 – HDD Cross River	As shown @A0
60634578-ACM-DR-CE-045	N6 HDD	As shown @A0
21337-MWP-00-00-DR-C-2125	Drainage & Cable Route Layout - North Drawing Location Plan	1:5000 @A1
21337-MWP-00-00-DR-C-2126	Drainage & Cable Route Layout - South Drawing Location Plan	1:1000 @A1
21337-MWP-WF-00-DR-C-2101	Proposed Drainage Layout Sheet 01	1:1000 @A1
21337-MWP-ZZ-00-DR-C-2102	Proposed Drainage Layout Sheet 02	1:1000 @A1
21337-MWP-ZZ-00-DR-C-2103	Proposed Drainage Layout Sheet 03	1:1000 @A1
21337-MWP-ZZ-00-DR-C-2104	Proposed Drainage Layout Sheet 04	1:1000 @A1
21337-MWP-ZZ-00-DR-C-2105	Proposed Drainage Layout Sheet 05	1:1000 @A1
21337-MWP-ZZ-00-DR-C-2106	Proposed Drainage Layout Sheet 06	1:1000 @A1
21337-MWP-ZZ-00-DR-C-2107	Proposed Drainage Layout Sheet 07	1:1000 @A1
21337-MWP-ZZ-00-DR-C-2108	Proposed Drainage Layout Sheet 08	1:1000 @A1
21337-MWP-ZZ-00-DR-C-2109	Proposed Drainage Layout Sheet 09	1:1000 @A1
21337-MWP-ZZ-00-DR-C-2110	Proposed Drainage Layout Sheet 10	1:1000 @A1
21337-MWP-00-00-DR-C-2111	Proposed Drainage Layout Sheet 11	1:1000 @A1
21337-MWP-00-00-DR-C-2112	Proposed Drainage Layout Sheet 12	1:1000 @A1
21337-MWP-00-00-DR-C-2113	Proposed Drainage Layout Sheet 13	1:1000 @A1
21337-MWP-00-00-DR-C-2114	Proposed Drainage Layout Sheet 14	1:1000 @A1
21337-MWP-00-00-DR-C-2115	Proposed Drainage Layout Sheet 15	1:1000 @A1
21337-MWP-00-00-DR-C-2116	Proposed Drainage Layout Sheet 16	1:1000 @A1
21337-MWP-00-00-DR-C-2117	Proposed Drainage Layout Sheet 17	1:1000 @A1
21337-MWP-00-00-DR-C-2118	Proposed Drainage Layout Sheet 18	1:1000 @A1
21337-MWP-00-00-DR-C-2119	Proposed Drainage Layout Sheet 19	1:1000 @A1
21337-MWP-00-00-DR-C-2120	Proposed Drainage Layout Sheet 20	1:1000 @A1
21337-MWP-00-00-DR-C-2121	Proposed Drainage Layout Sheet 21	1:1000 @A1
21337-MWP-00-00-DR-C-2122	Proposed Drainage Layout Sheet 22	1:1000 @A1
21337-MWP-00-00-DR-C-2123	Proposed Drainage Layout Sheet 23	1:1000 @A1
21337-MWP-00-00-DR-C-2124	Proposed Drainage Layout Sheet 24	1:1000 @A1
21337-MWP-00-00-DR-C-2127	Fencing, Road and Drainage Details	1:50 @A1
21337-MWP-00-00-DR-C-2128	Grass Lined Linear Swale	1:50 @A1
21337-MWP-WF-00-DR-C-3000	Wind Farm Entrance Sightlines - Sheet 1	1:1000 @A1
21337-MWP-WF-00-DR-C-3001	Wind Farm Entrance Sightlines - Sheet 2	1:1000 @A1
21337-MWP-WF-00-DR-C-3002	Wind Farm Entrance Sightlines - Sheet 3	1:1000 @A1


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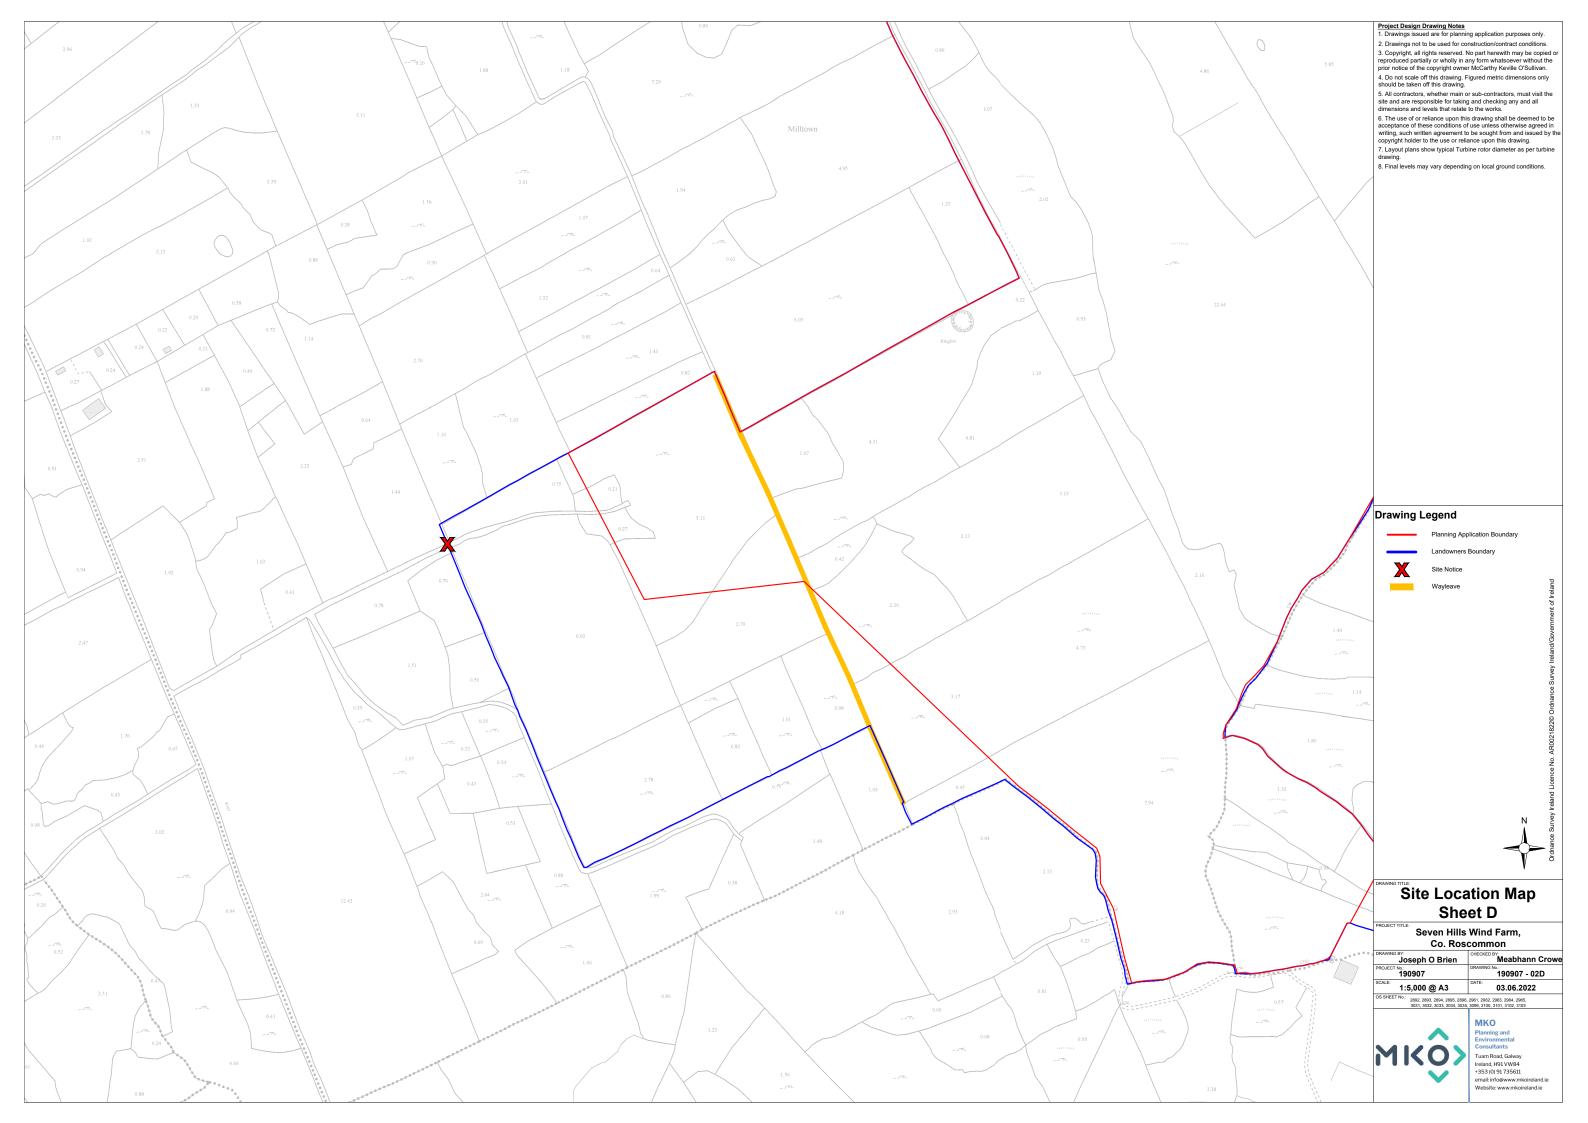


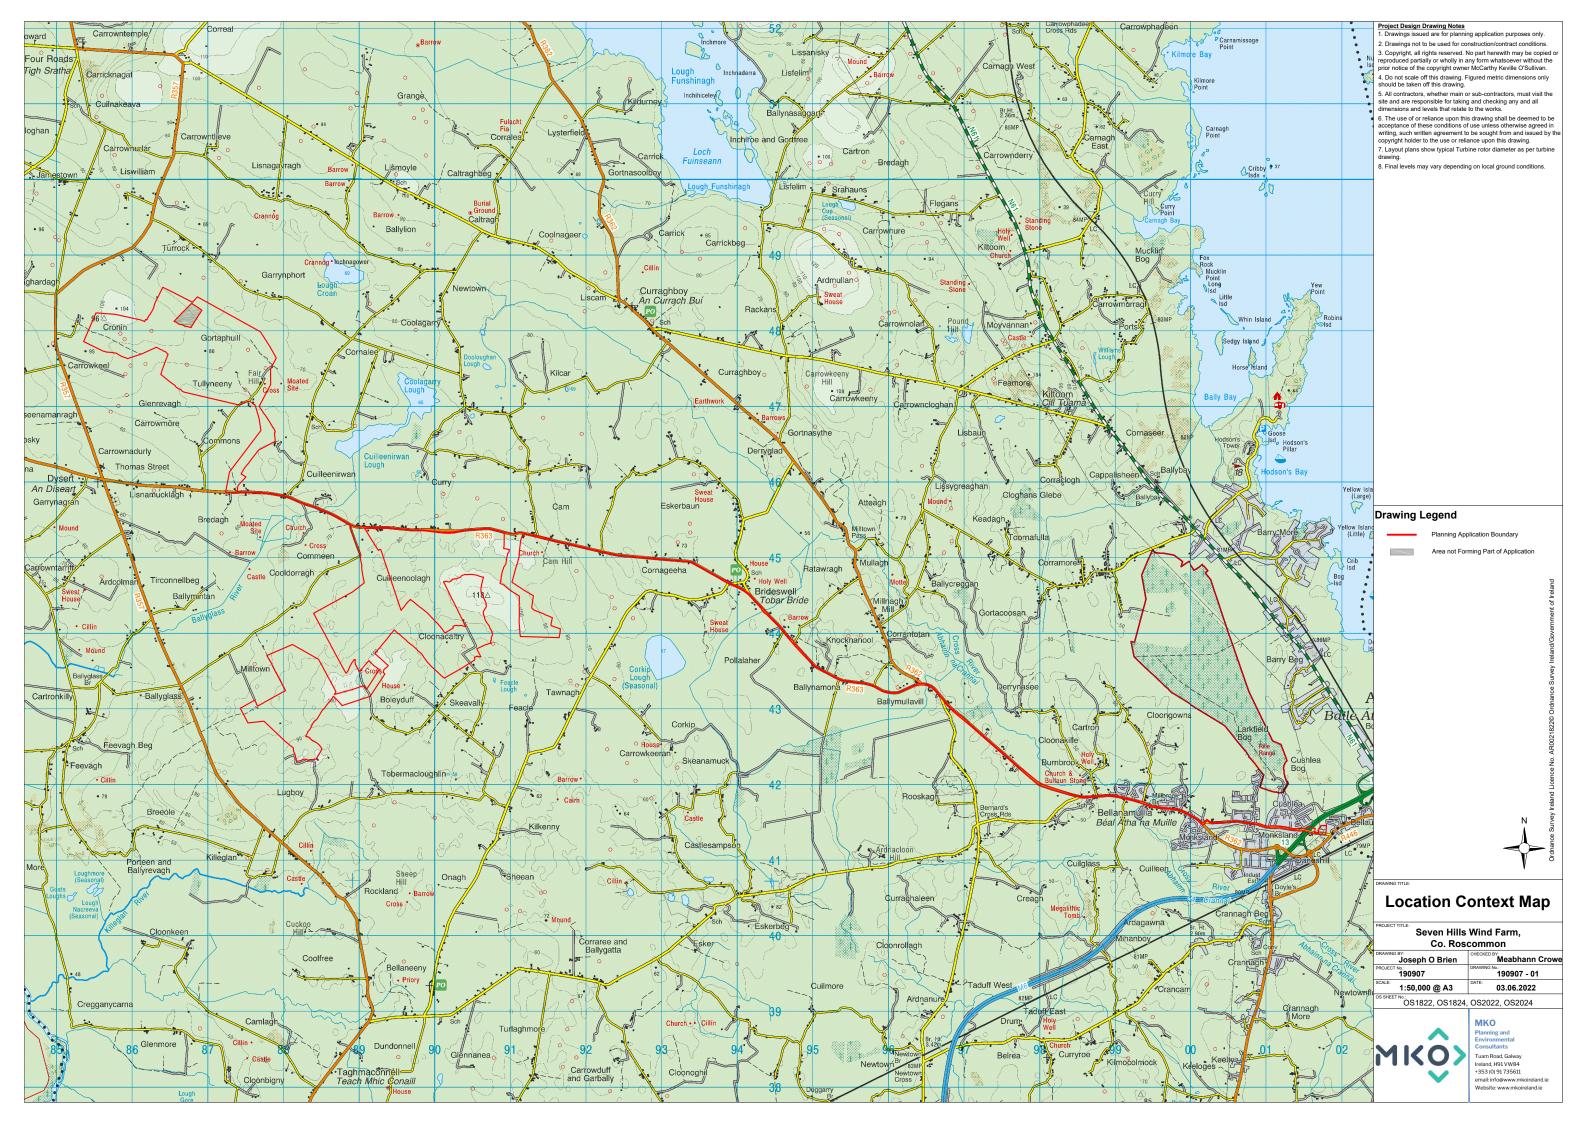


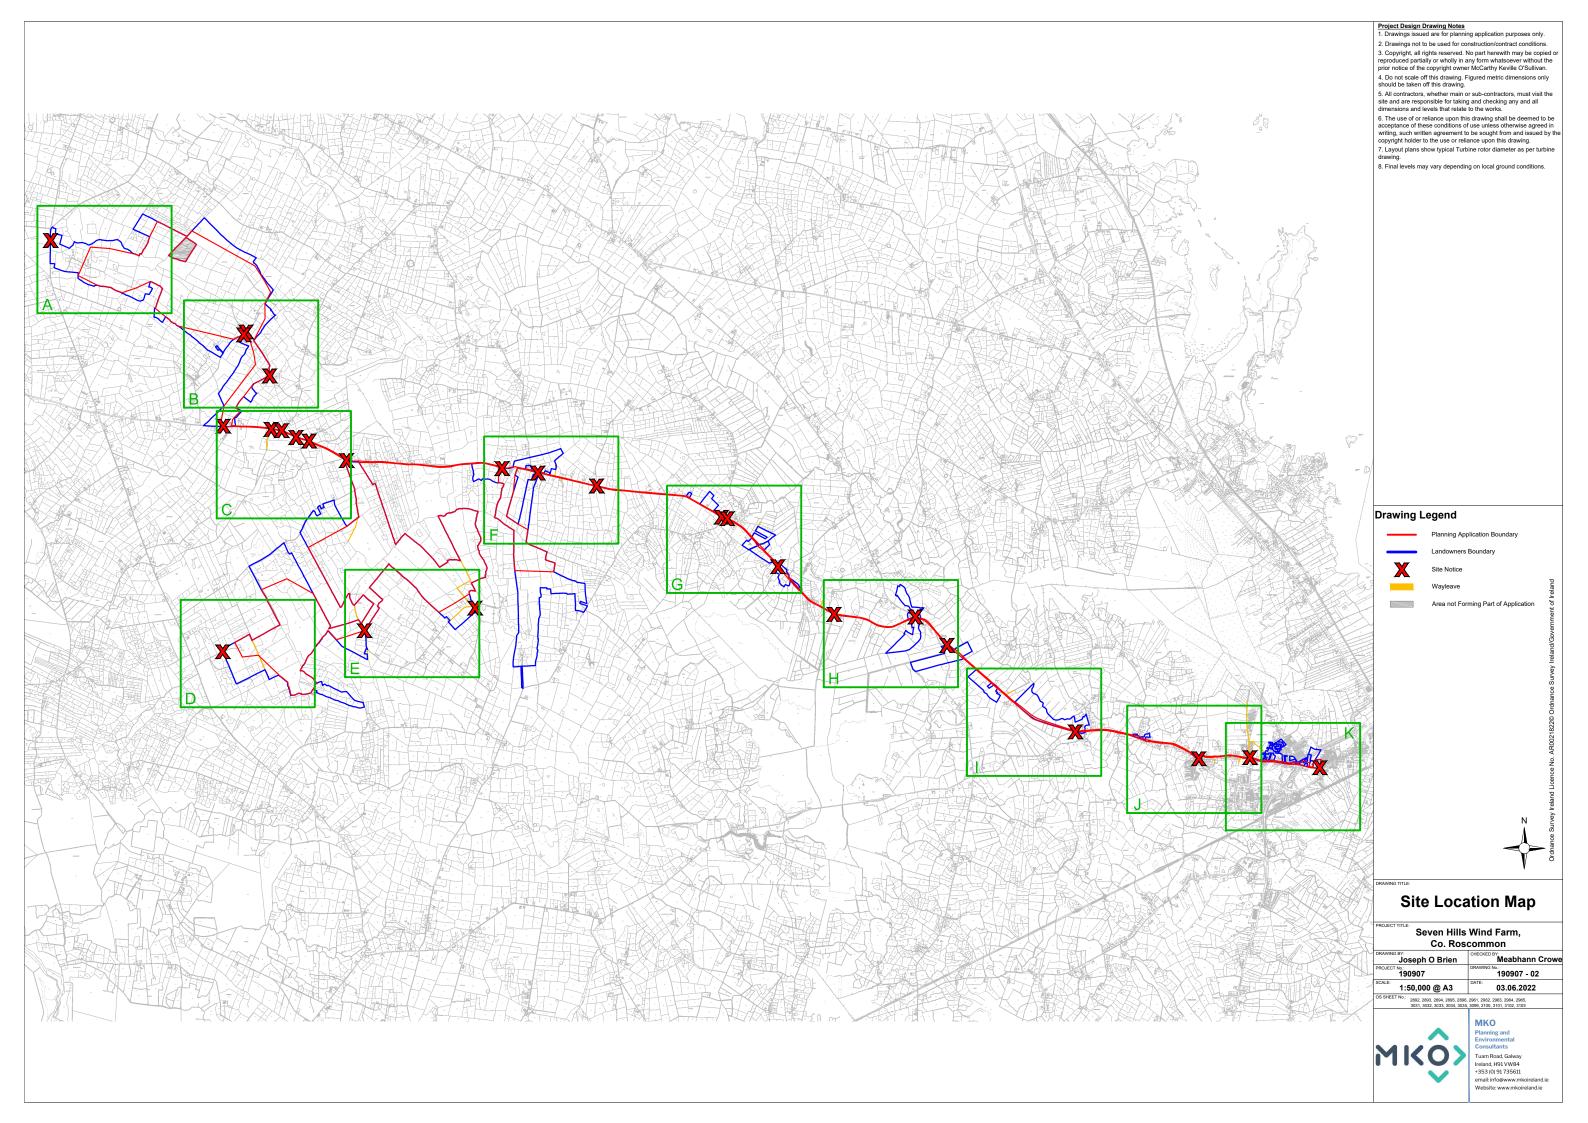


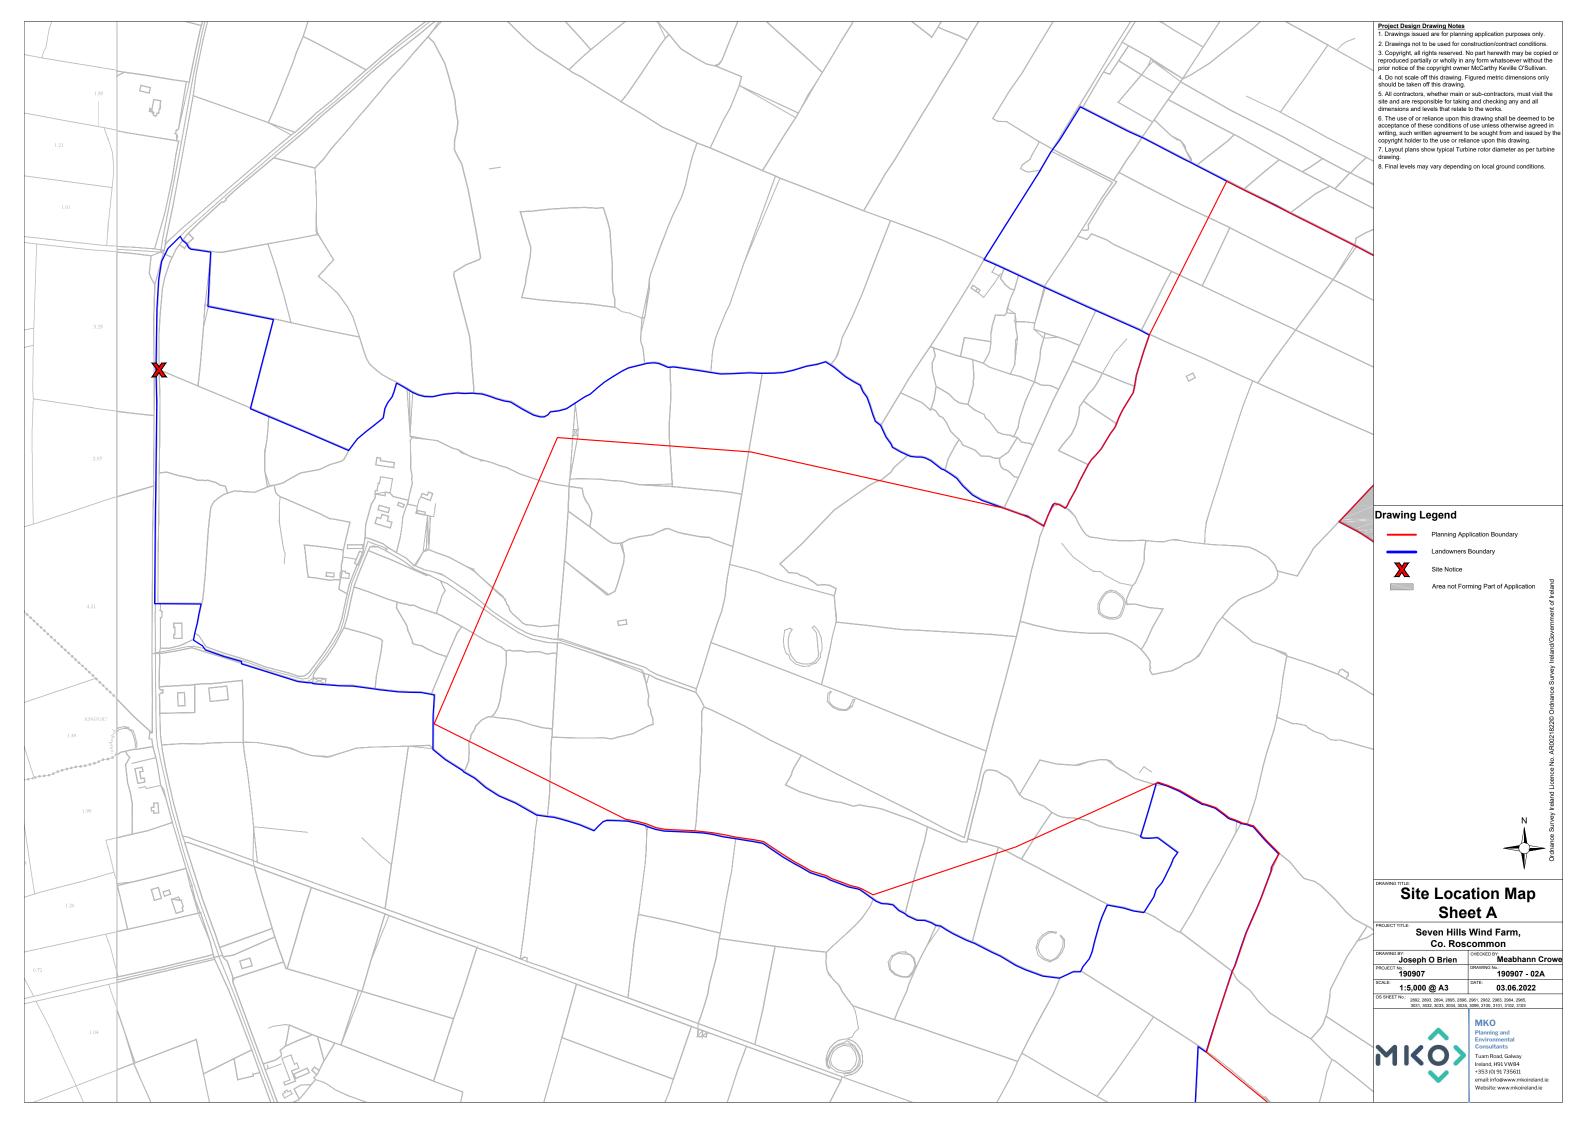


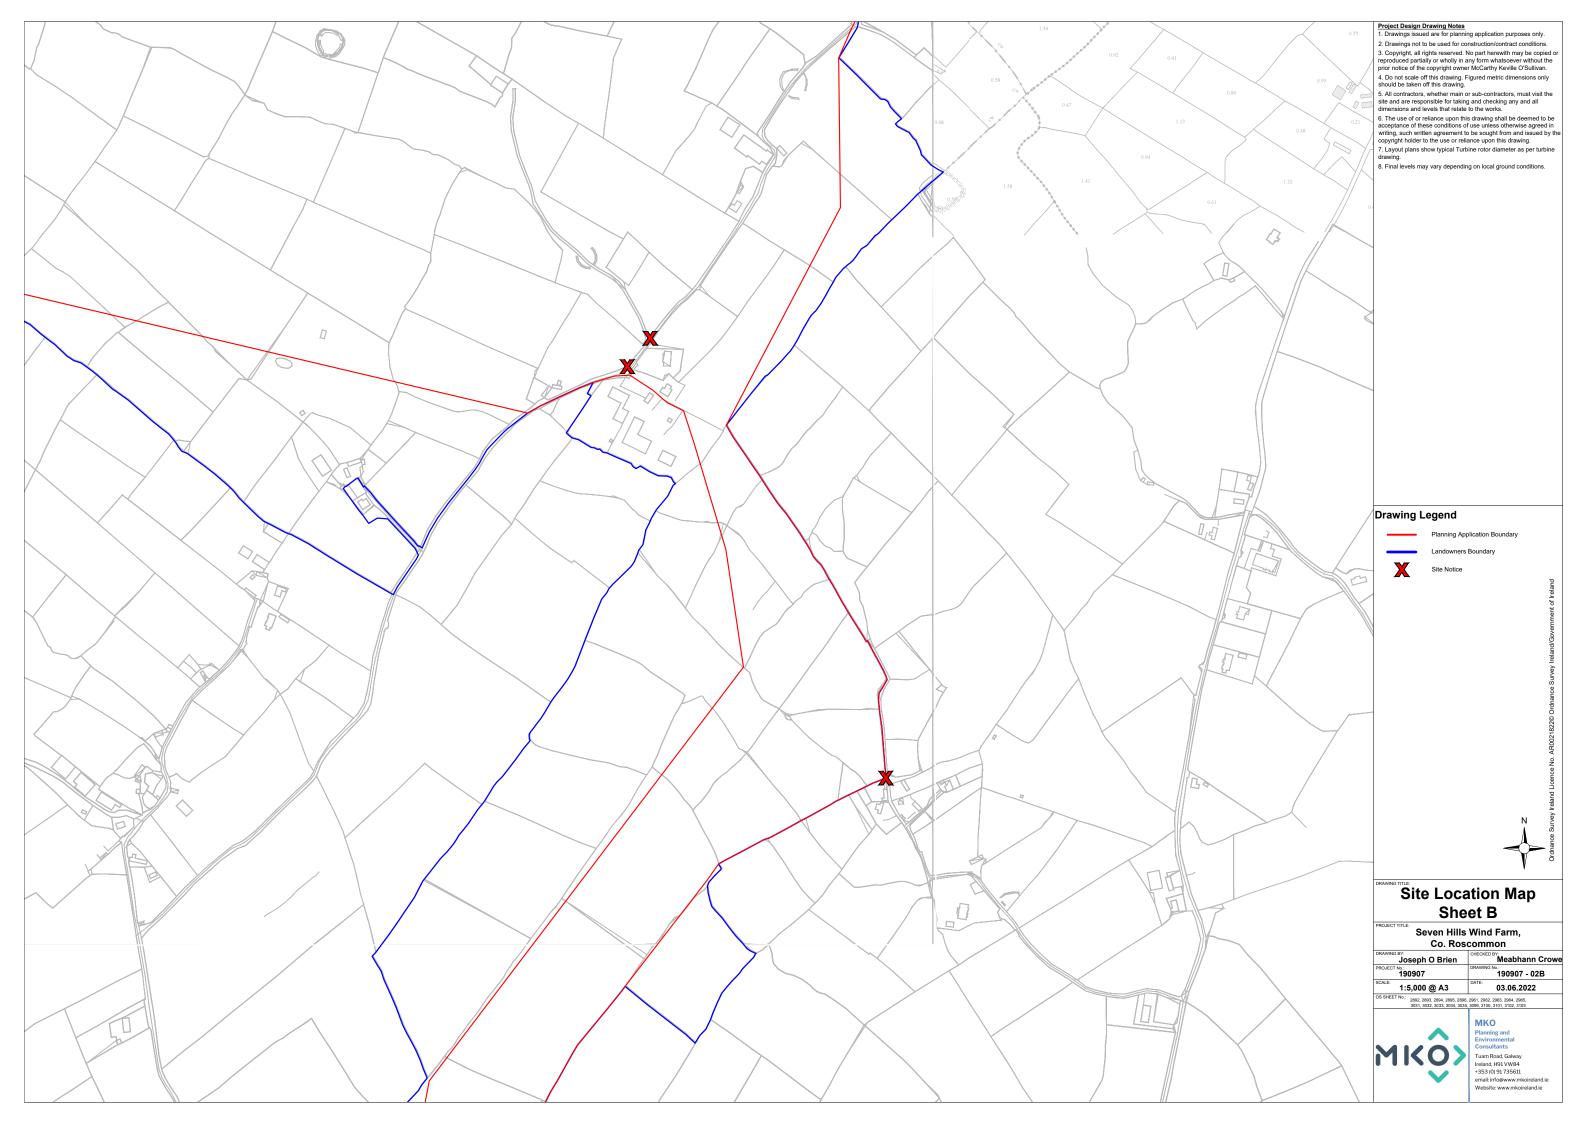


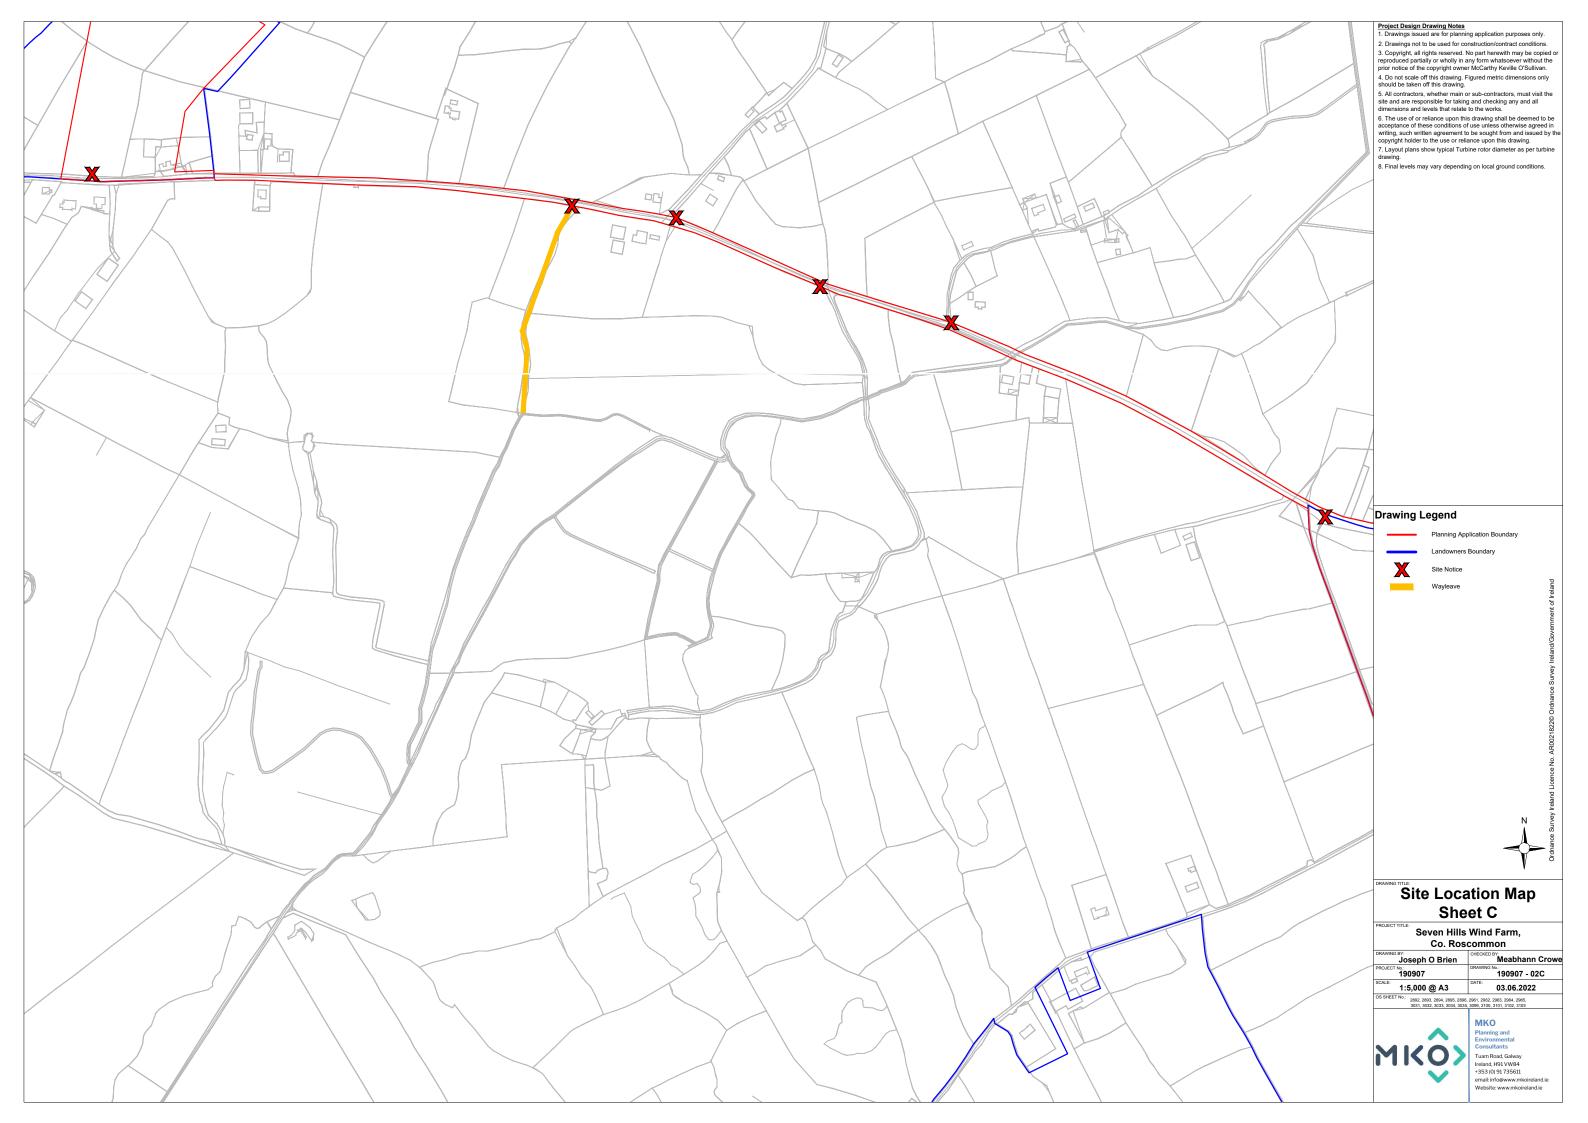

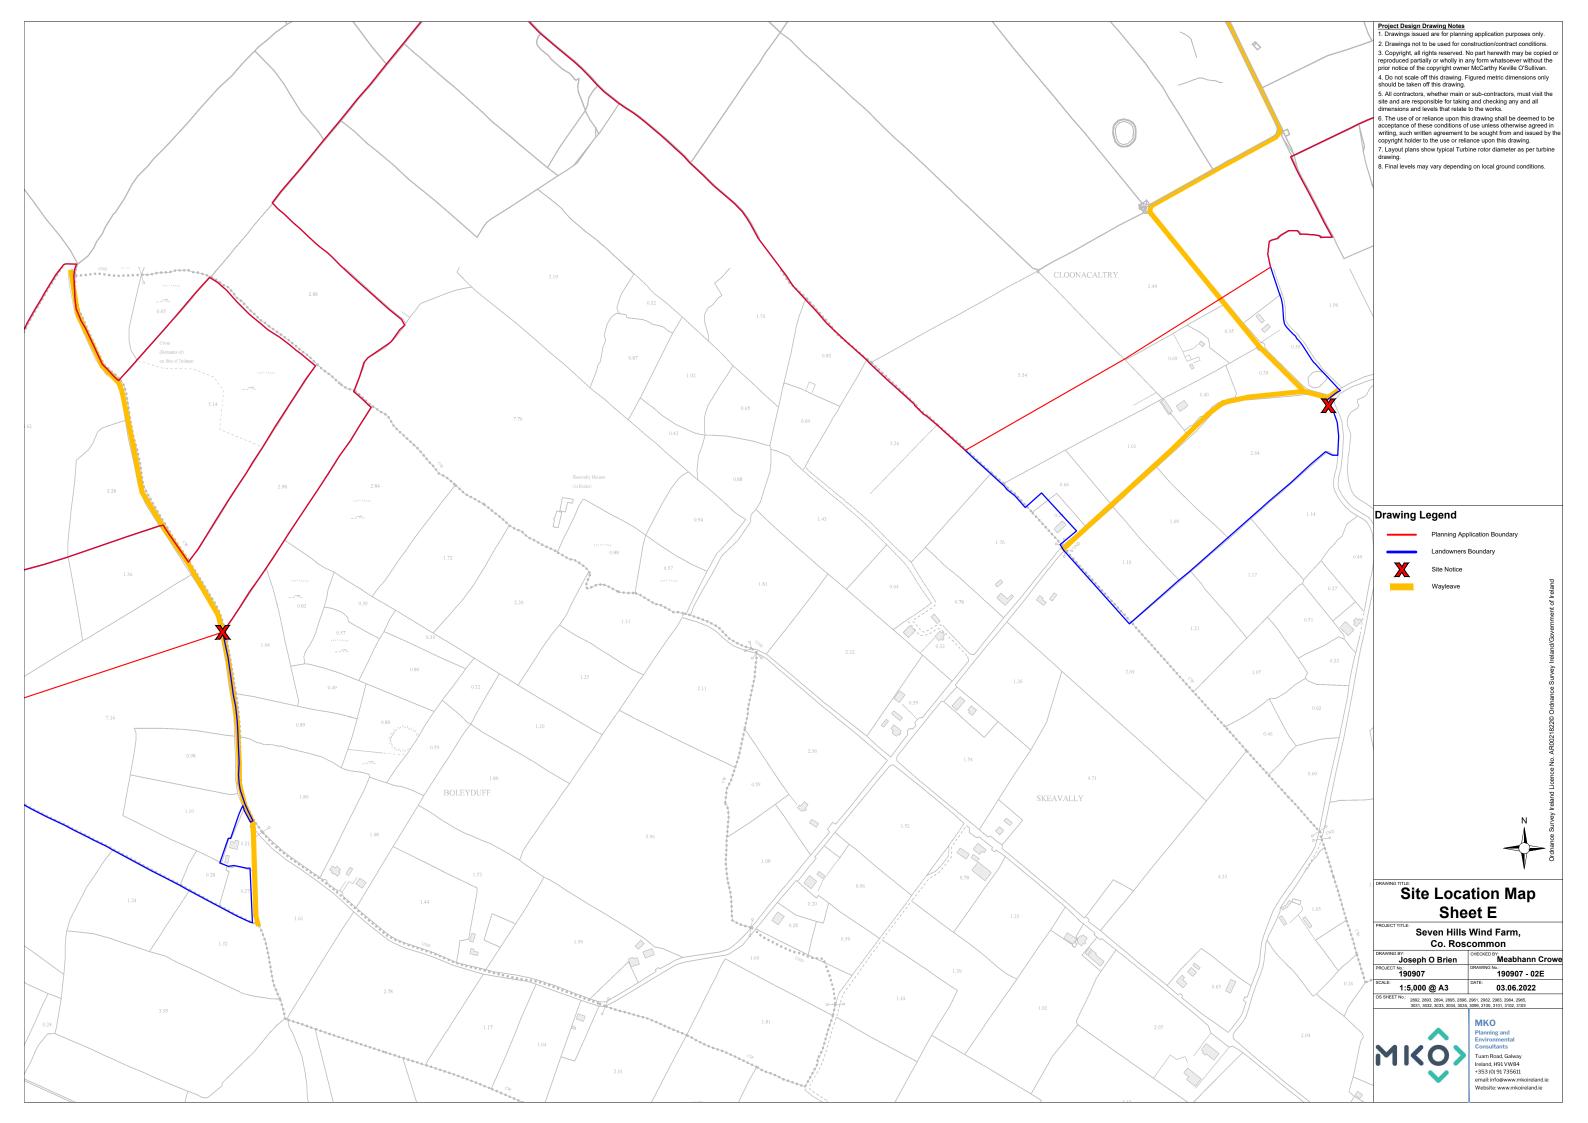


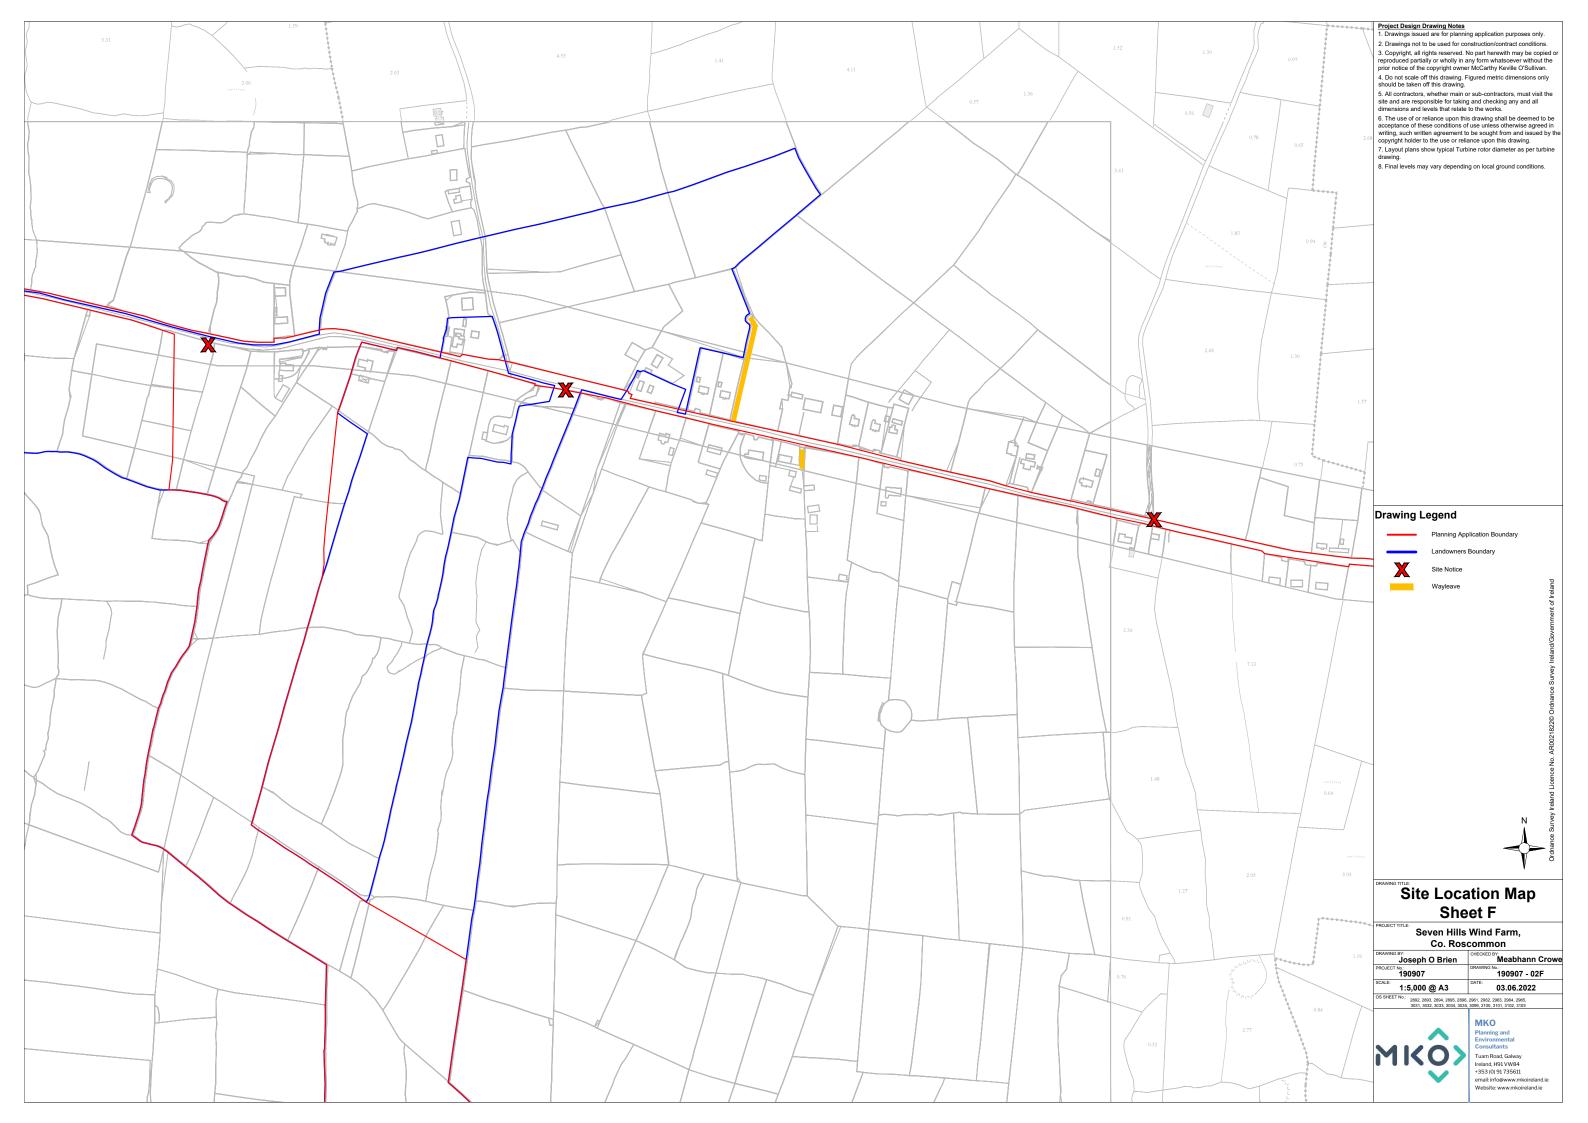


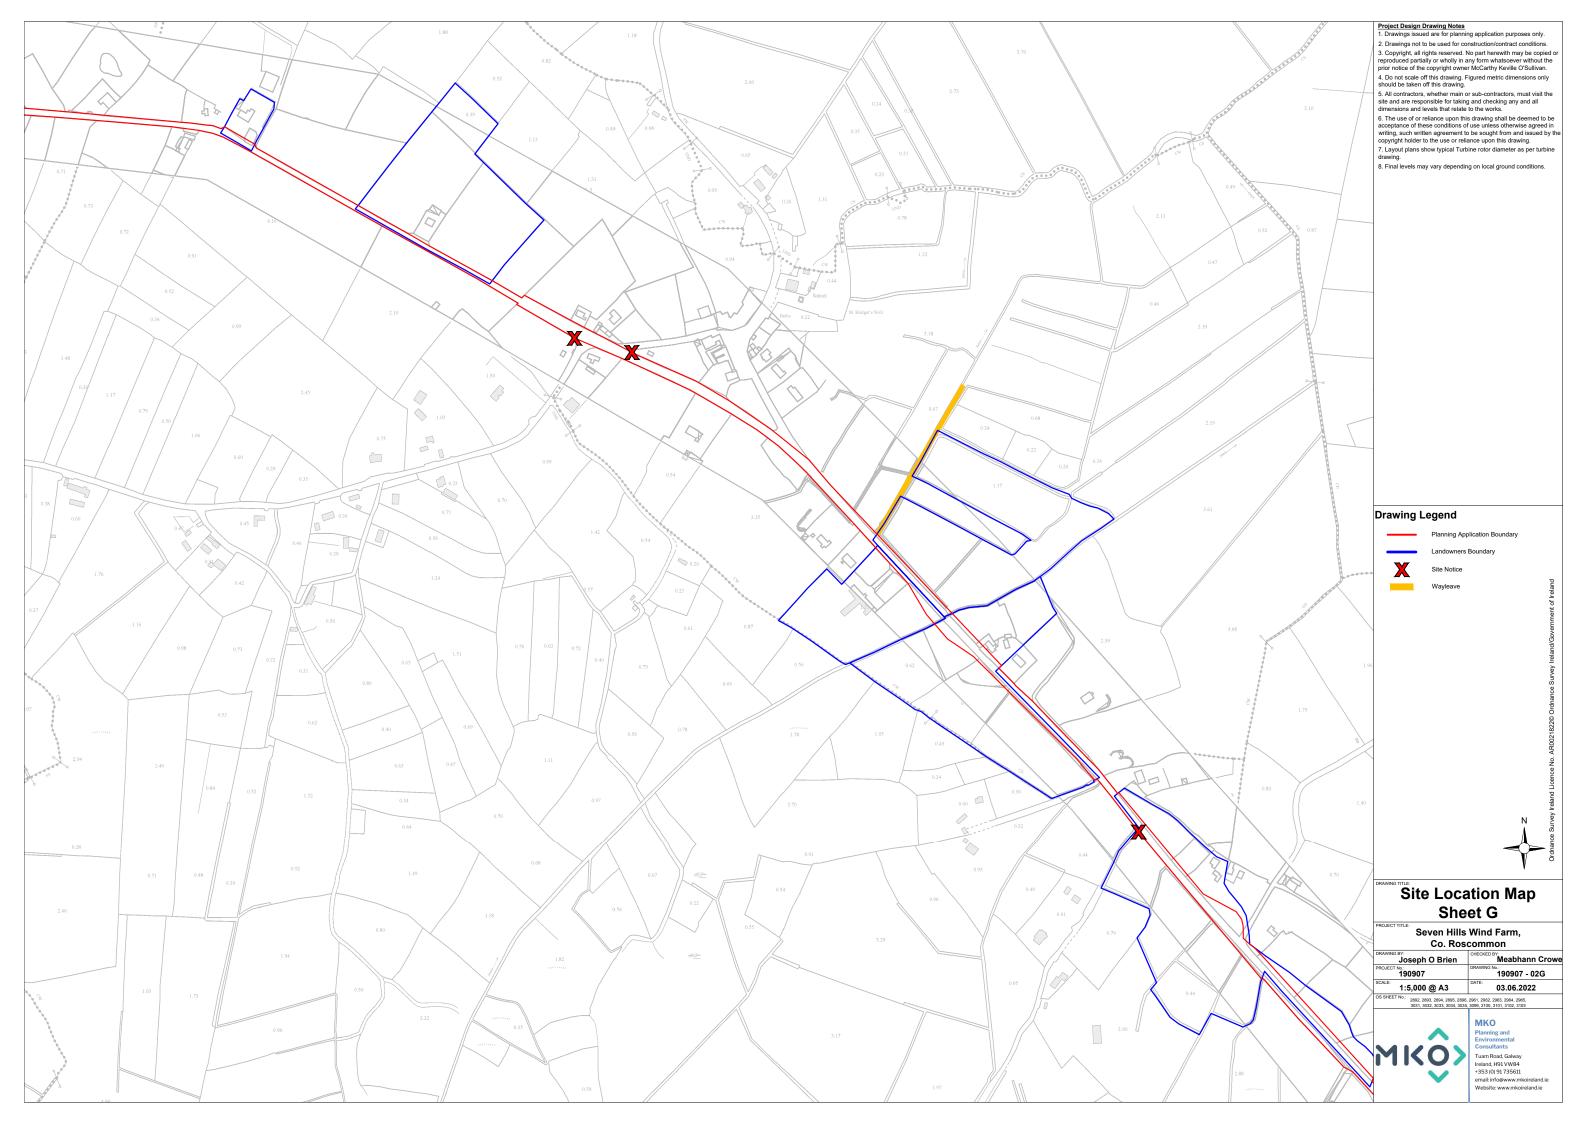

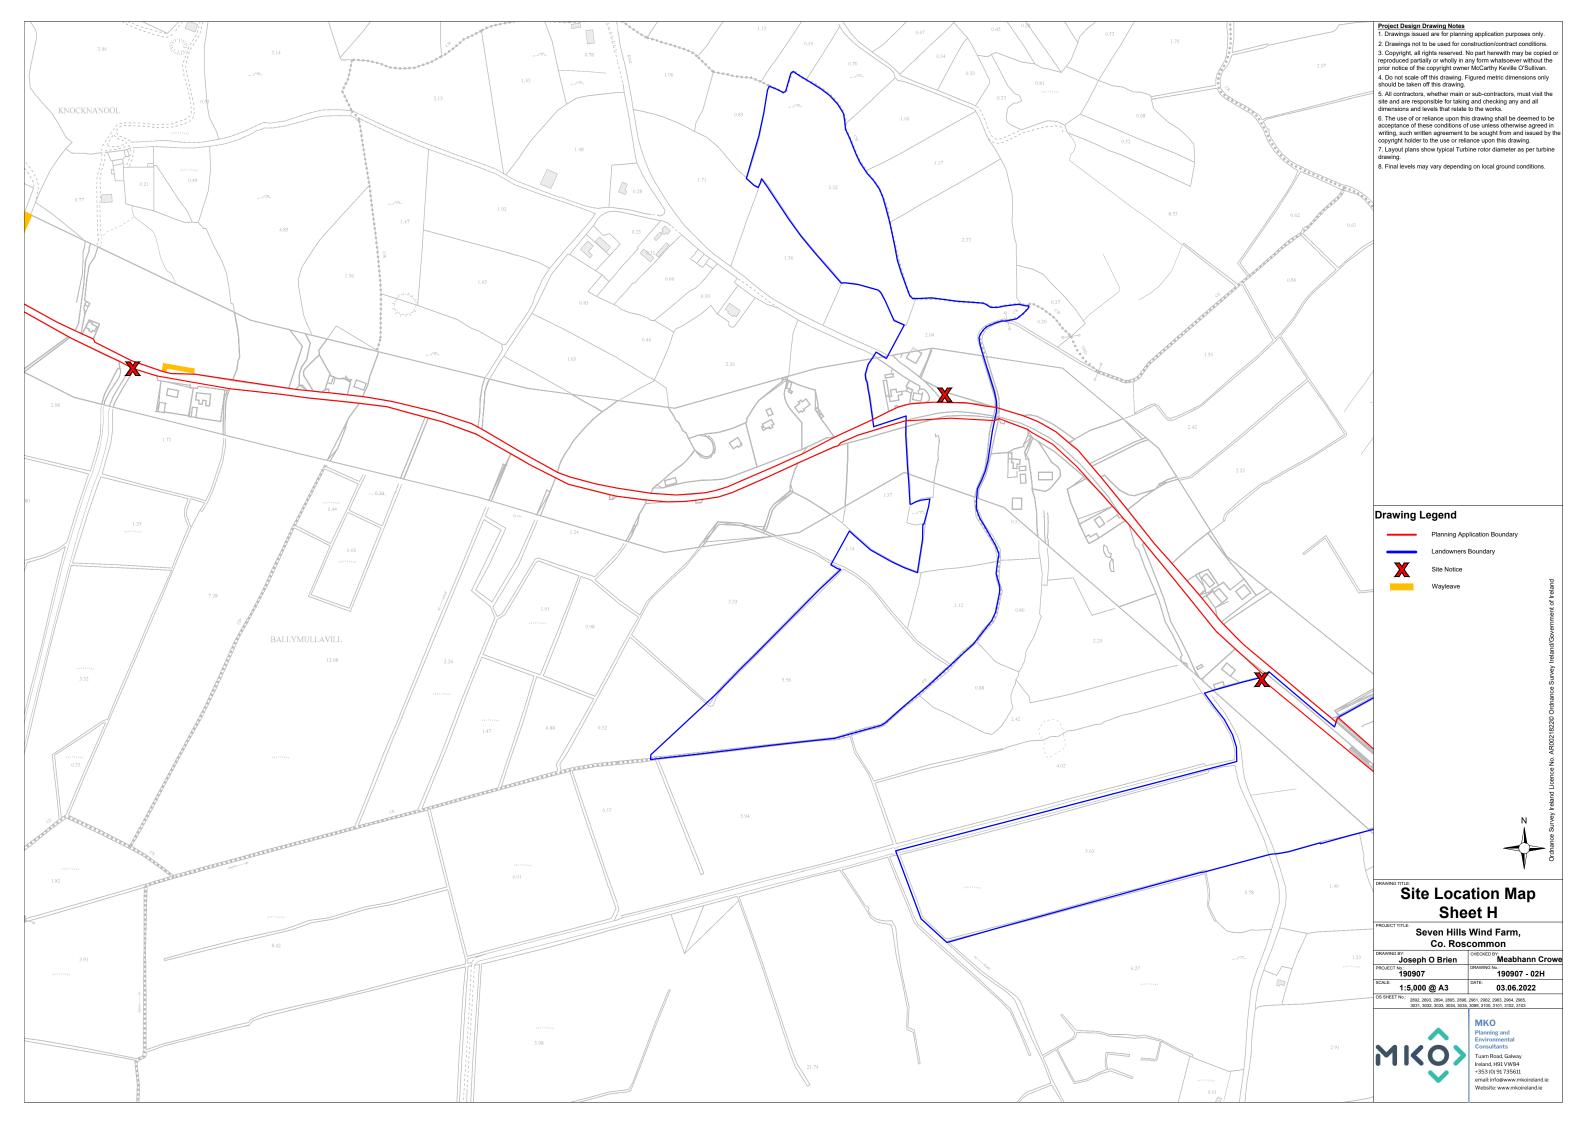



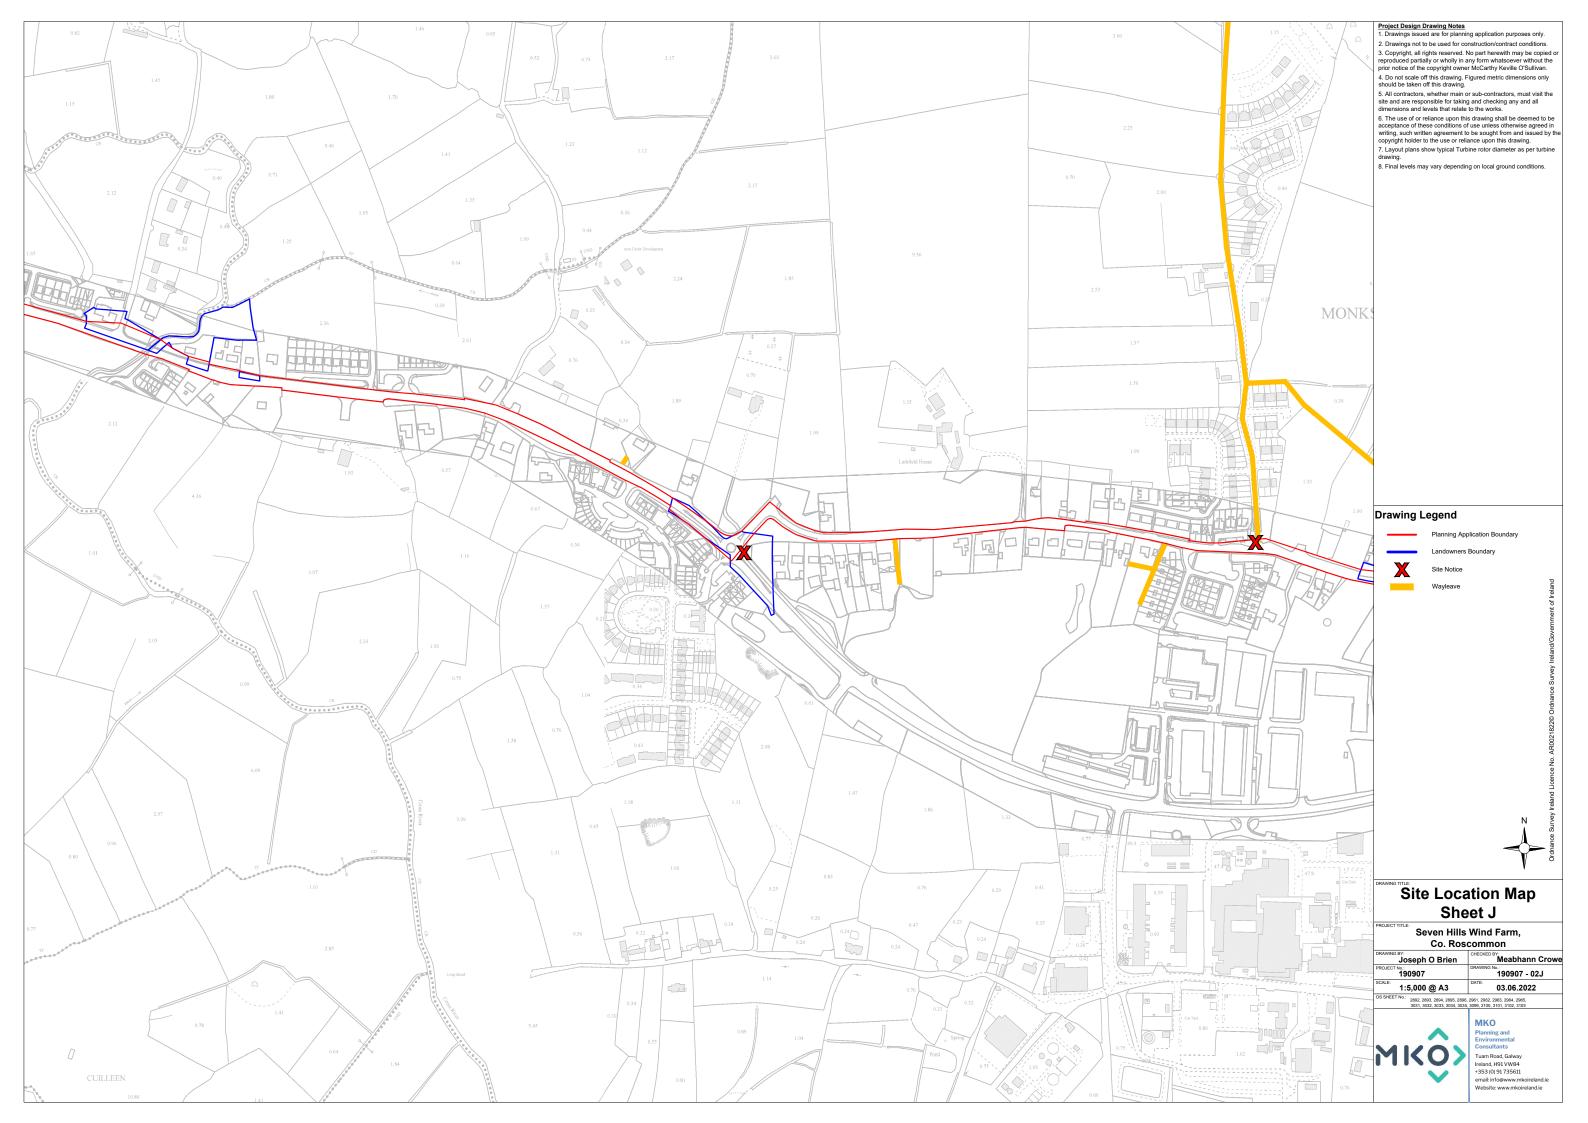

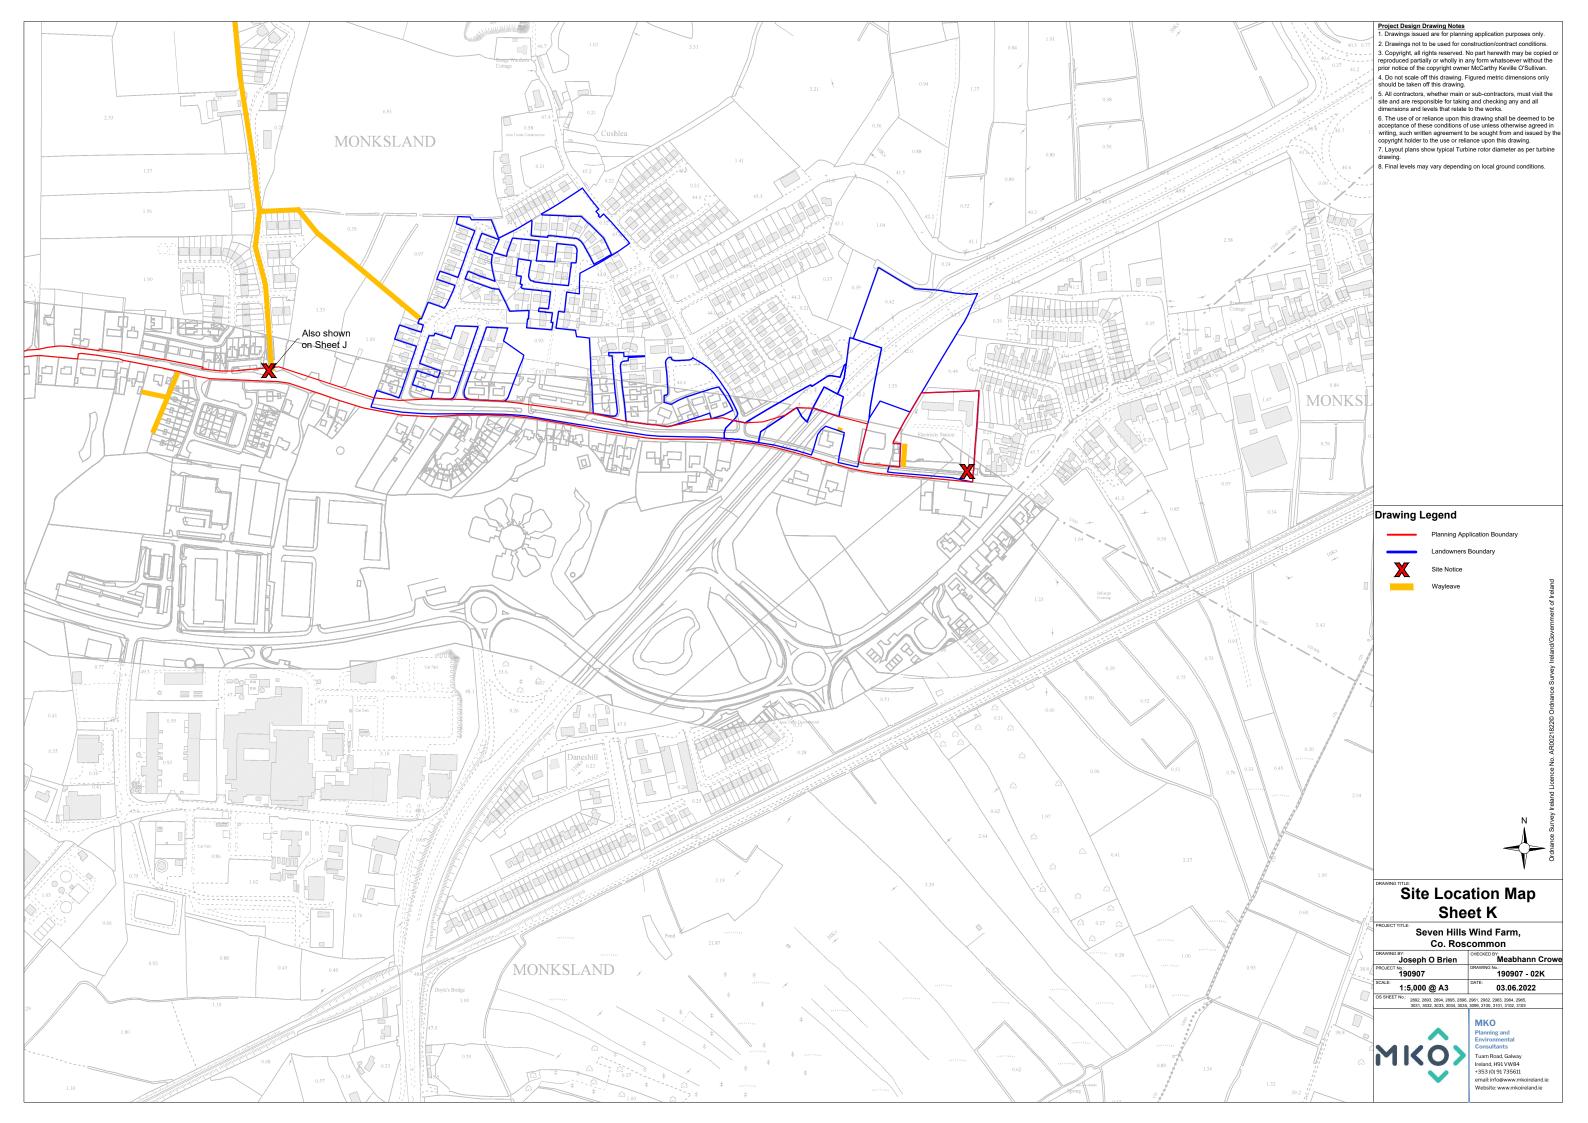



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8. Final levels may vary depending on local ground conditions.

Drawing Legend

	Planning Application Boundary	
	Existing Road to be Upgraded	
	Proposed Road	
 	Internal Electrical Cabling Trench	eland
	110kV Cable Route	nt of Ir
	IPP Cabling	rnmer
	N6 HDD	I/Gove
_	Joint Bay - 110kV	Irelanc
	Joint Bay Array North	urvey
	Joint Bay Array South	ince Si
	Potential HDD	Ordna
	Soft Levelled Area	822©
	Crane Pad Hardstanding Area	AR0021
	Turbine Foundation	e No. ⊿
	Turbine Sweep Area	0 ordnance Survey Ireland Licence No. AR0021822© Ordnance Survey Ireland/Government of Ireland
	Area not Forming Part of Application	Irelar
	Spoil Storage N	Survey
	Cut	ance (
	Fill	Ordn


Site Layout Key Plan (1:5,000)


PROJECT TITLE: Seven Hills Wind Farm, Co. Roscommon RAWING BY: Joseph O Brien Meabhann Crowe PROJECT No.: 190907 ^{No.:} 190907 - 03 SCALE 1:25,000 @ A1 03.06.2022 OS SHEET No.: 2892, 2893, 2894, 2895, 2896, 2961, 2962, 2963, 2964, 2965, 3031, 3032, 3033, 3034, 3035, 3099, 3100, 3101, 3102, 3103 MKO Planning and Environmental

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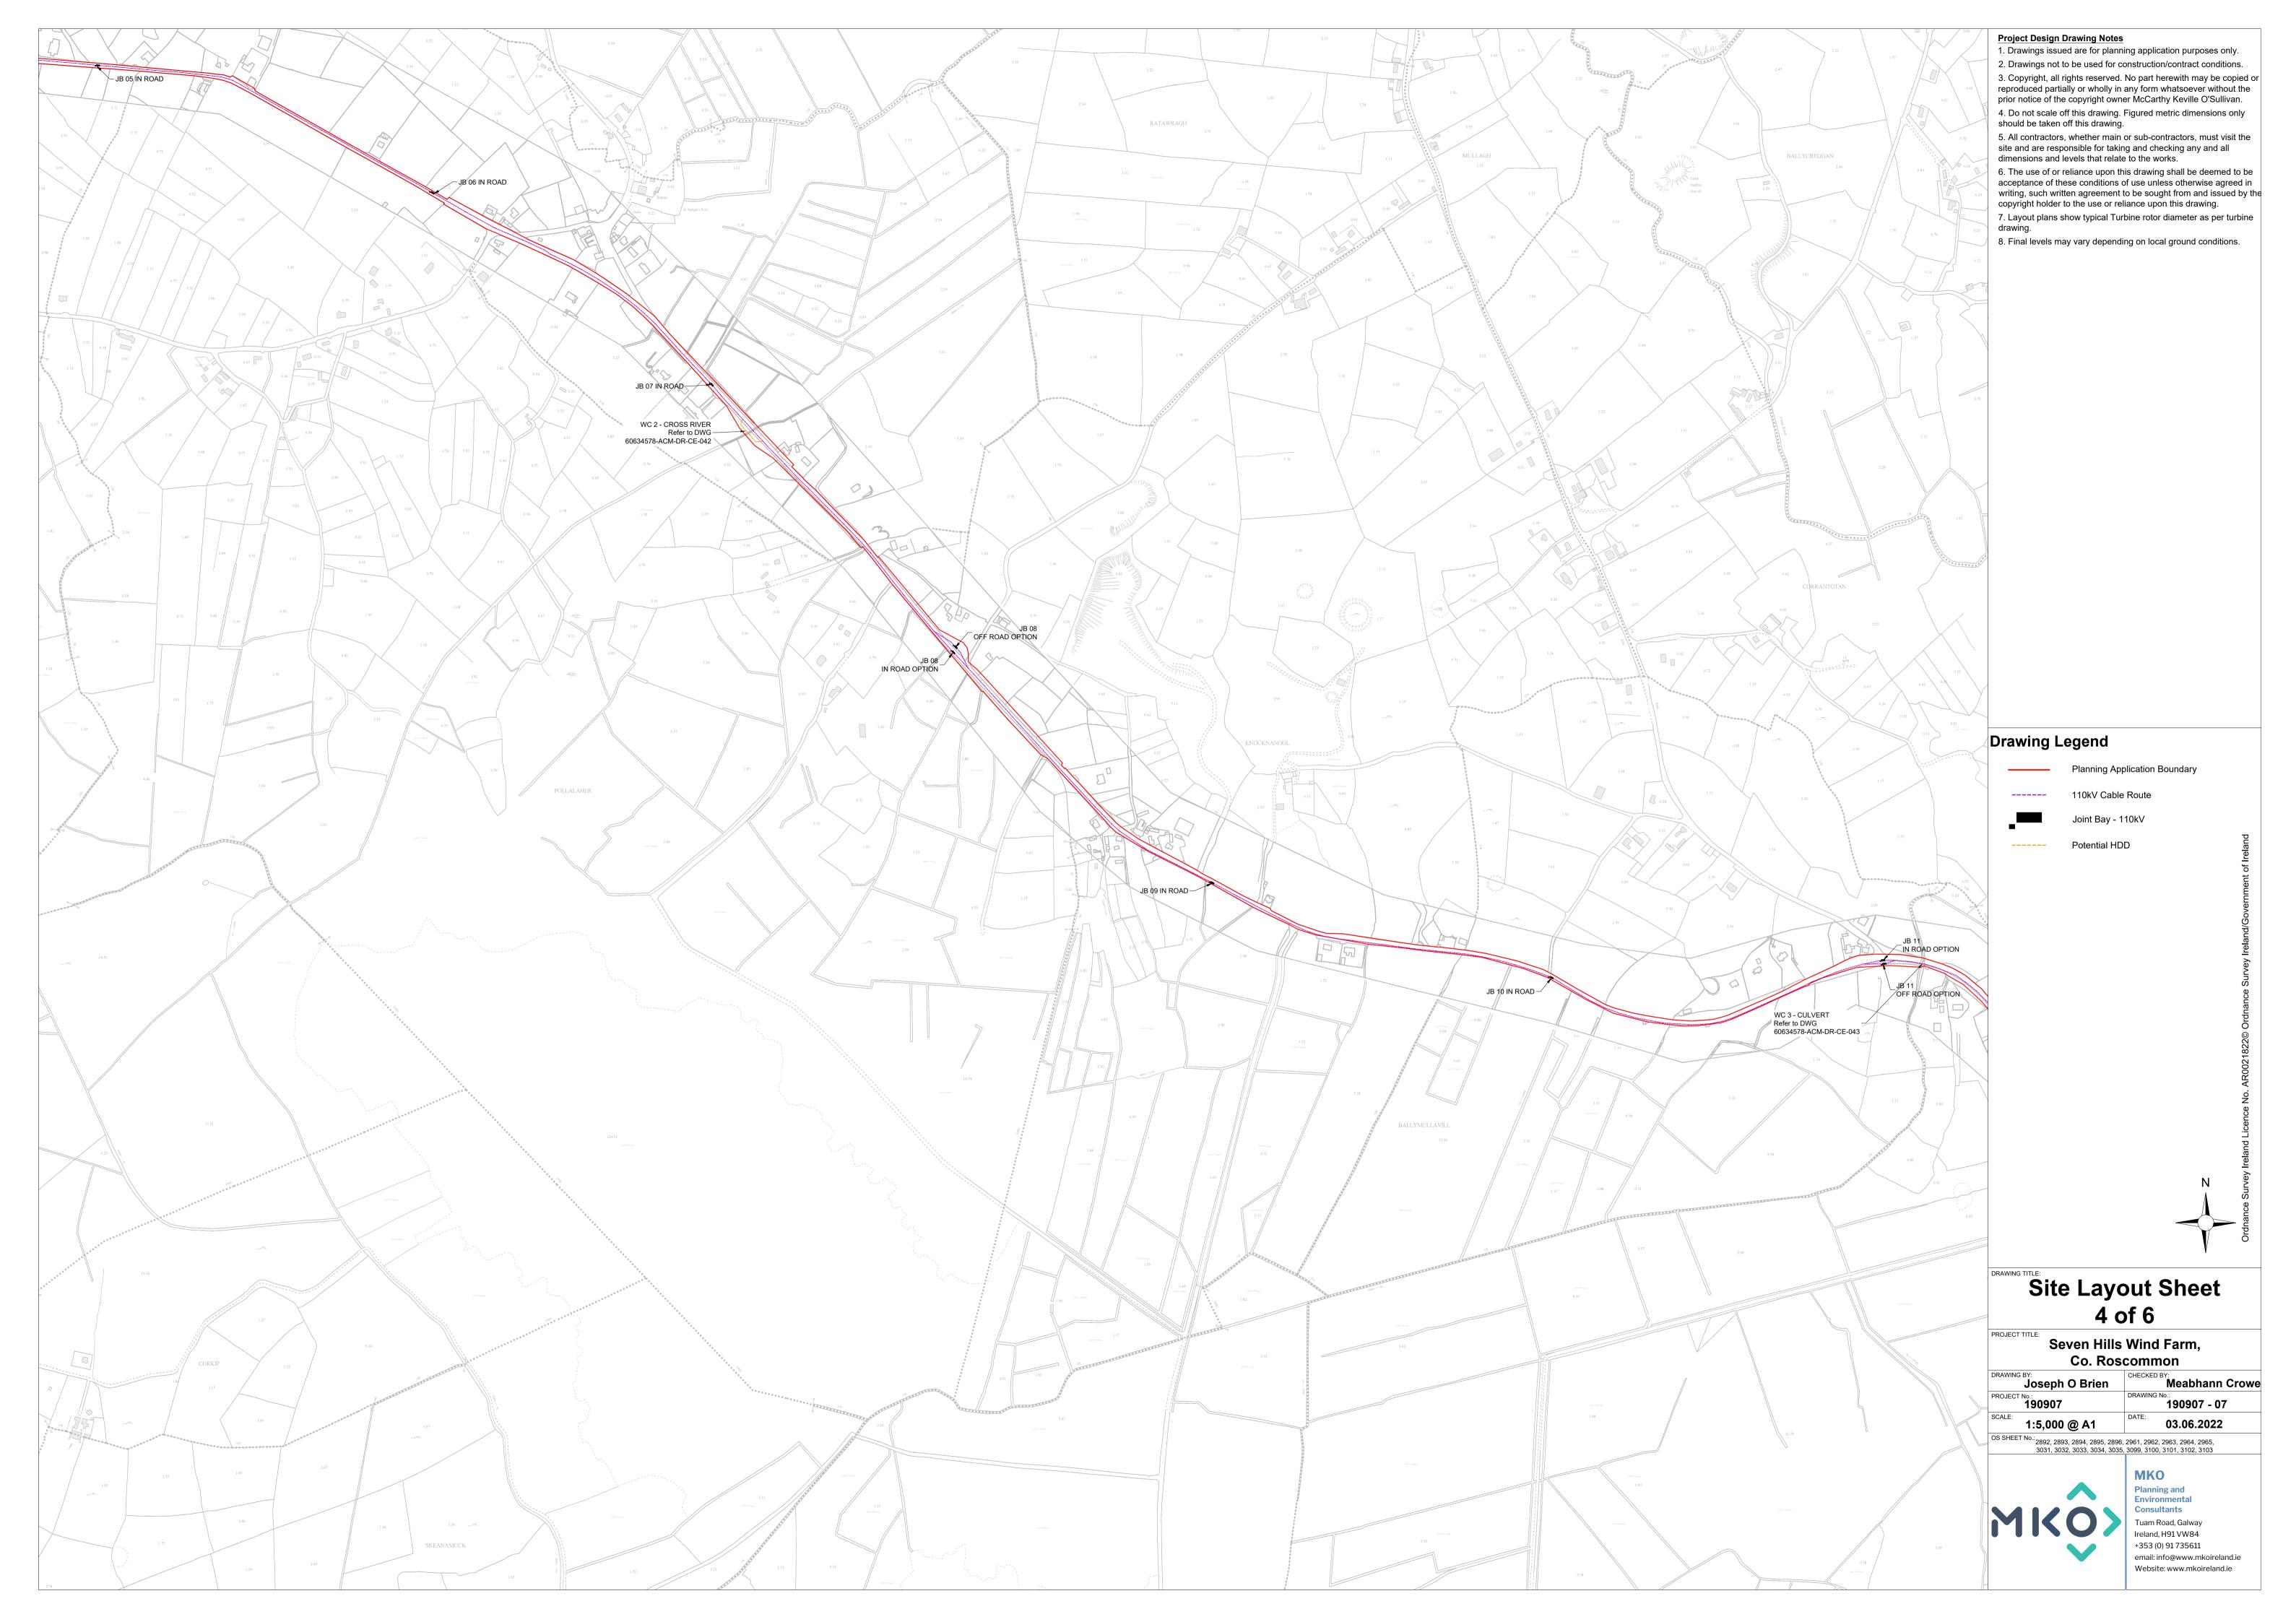
Consultants Tuam Road, Galway Ireland, H91 VW84 +353 (0) 91 735611 email: info@www.mkoireland.ie Website: www.mkoireland.ie





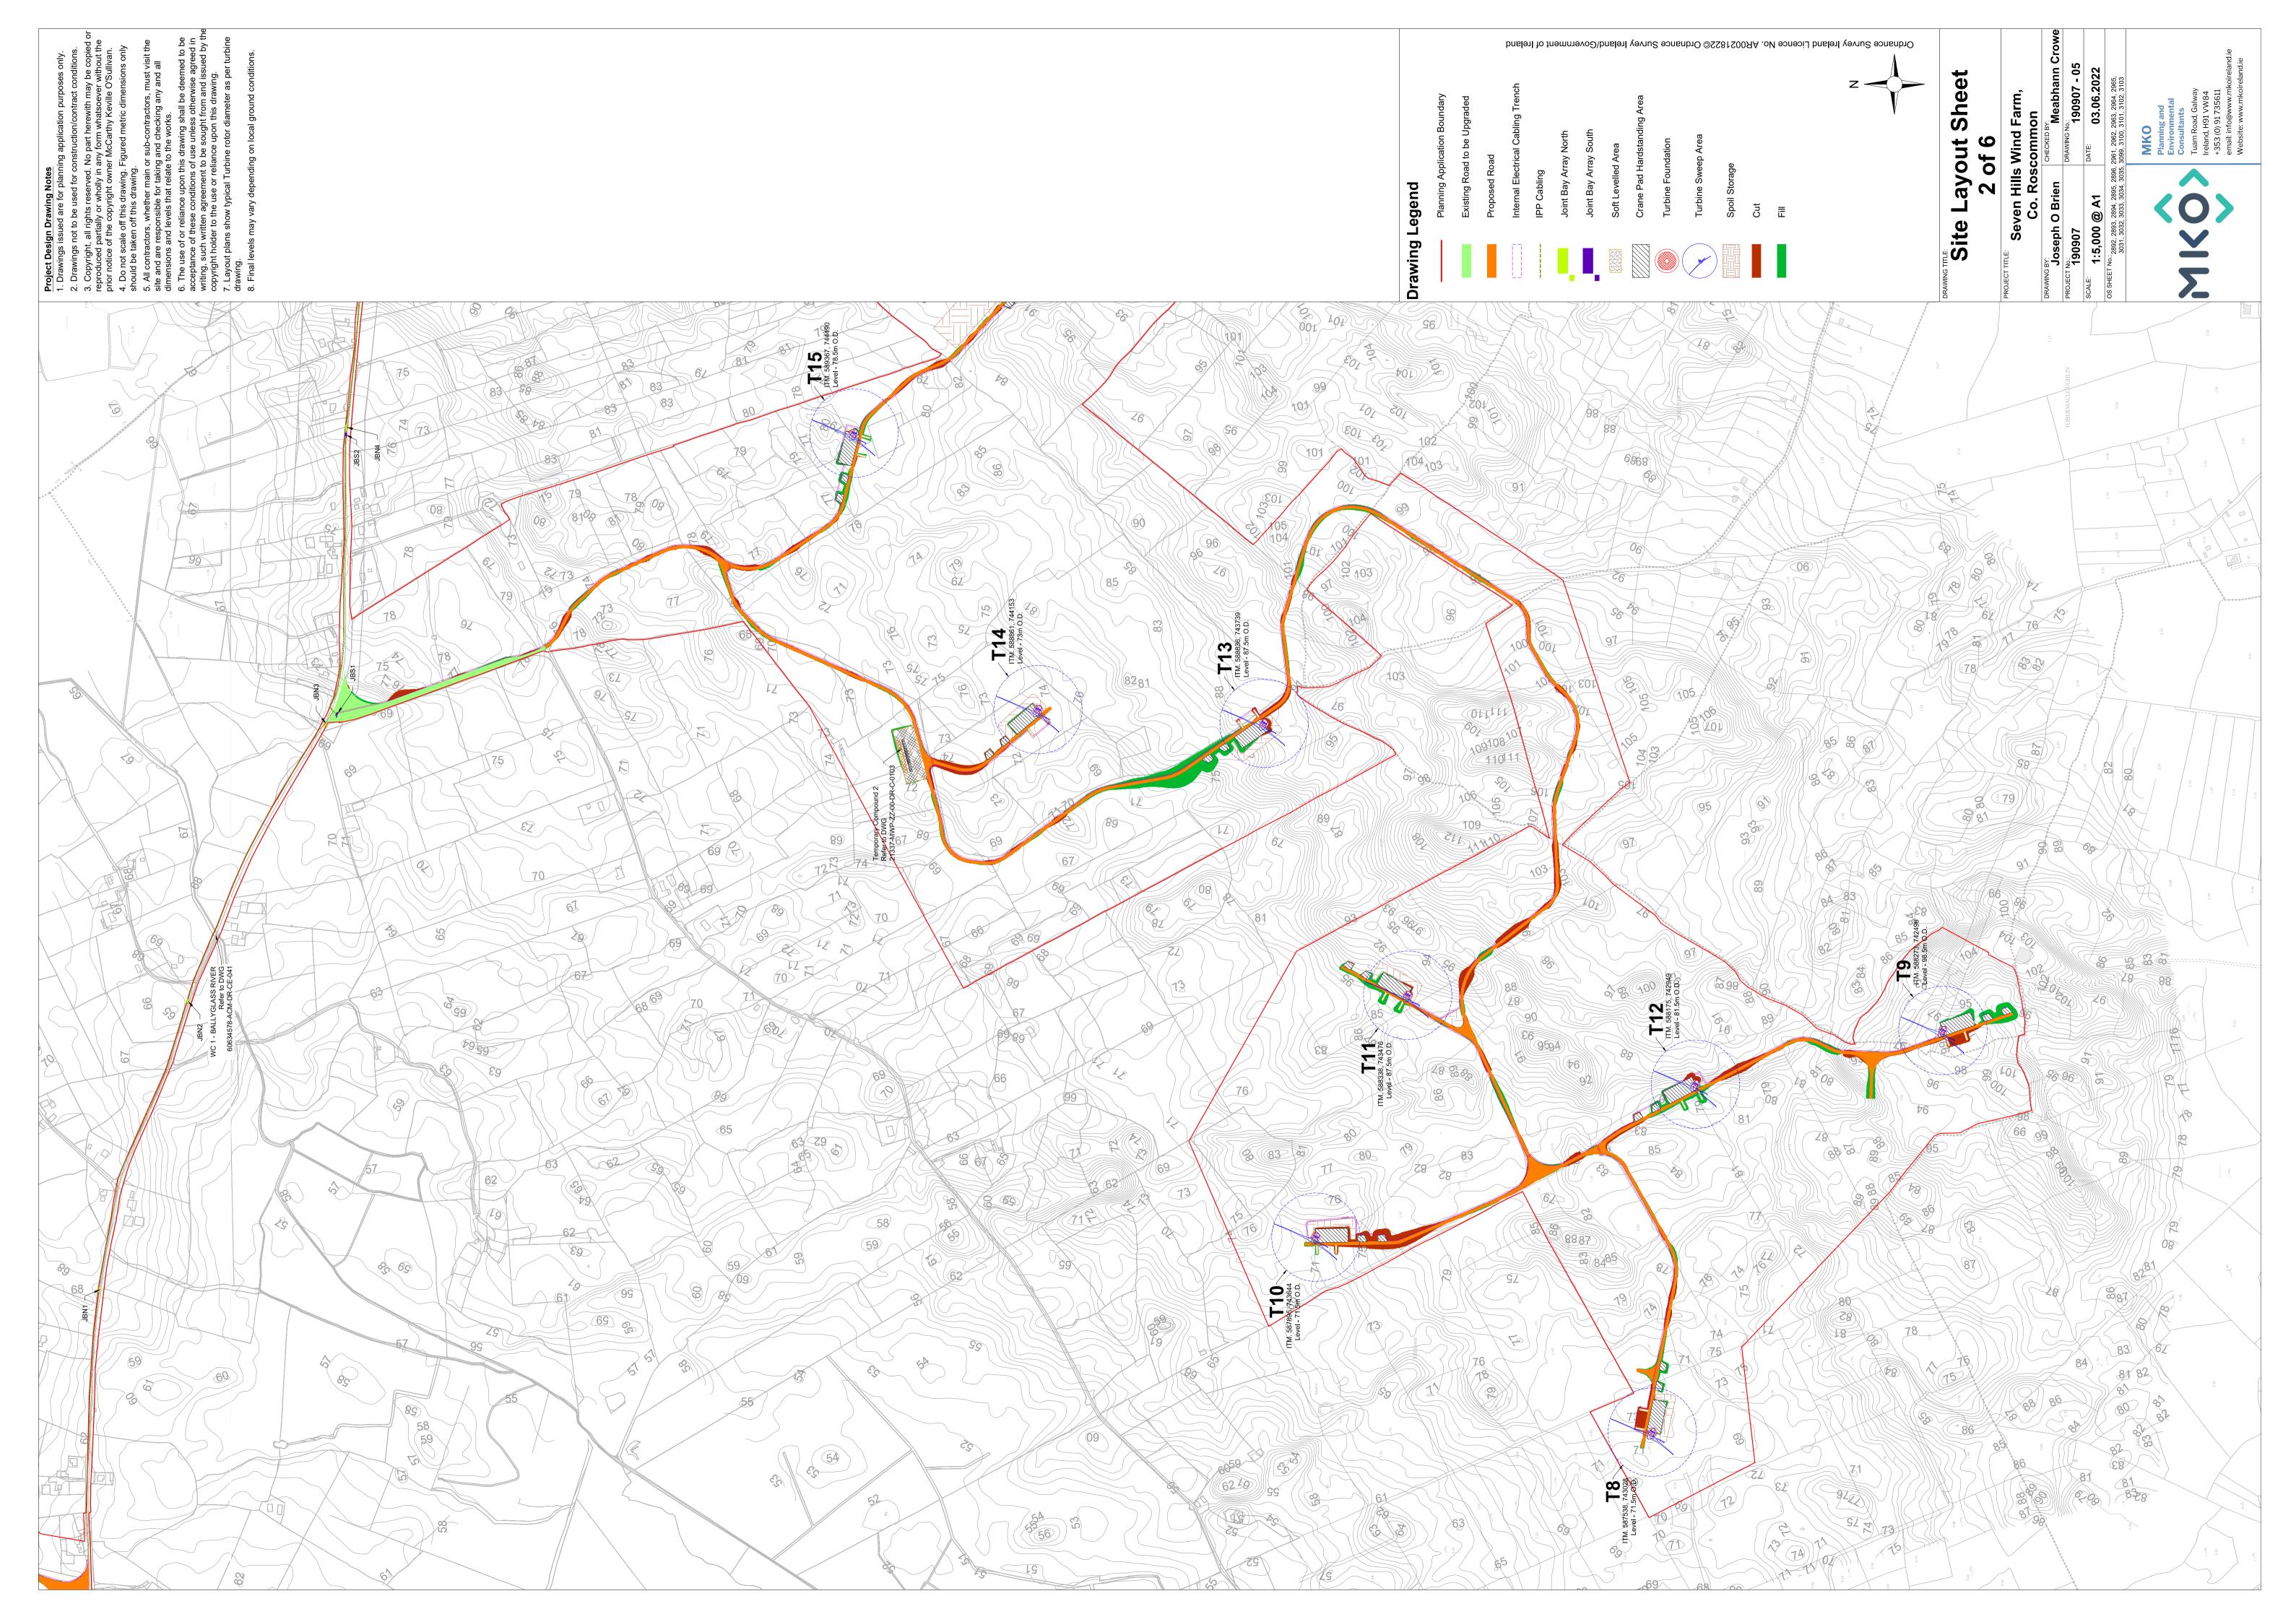

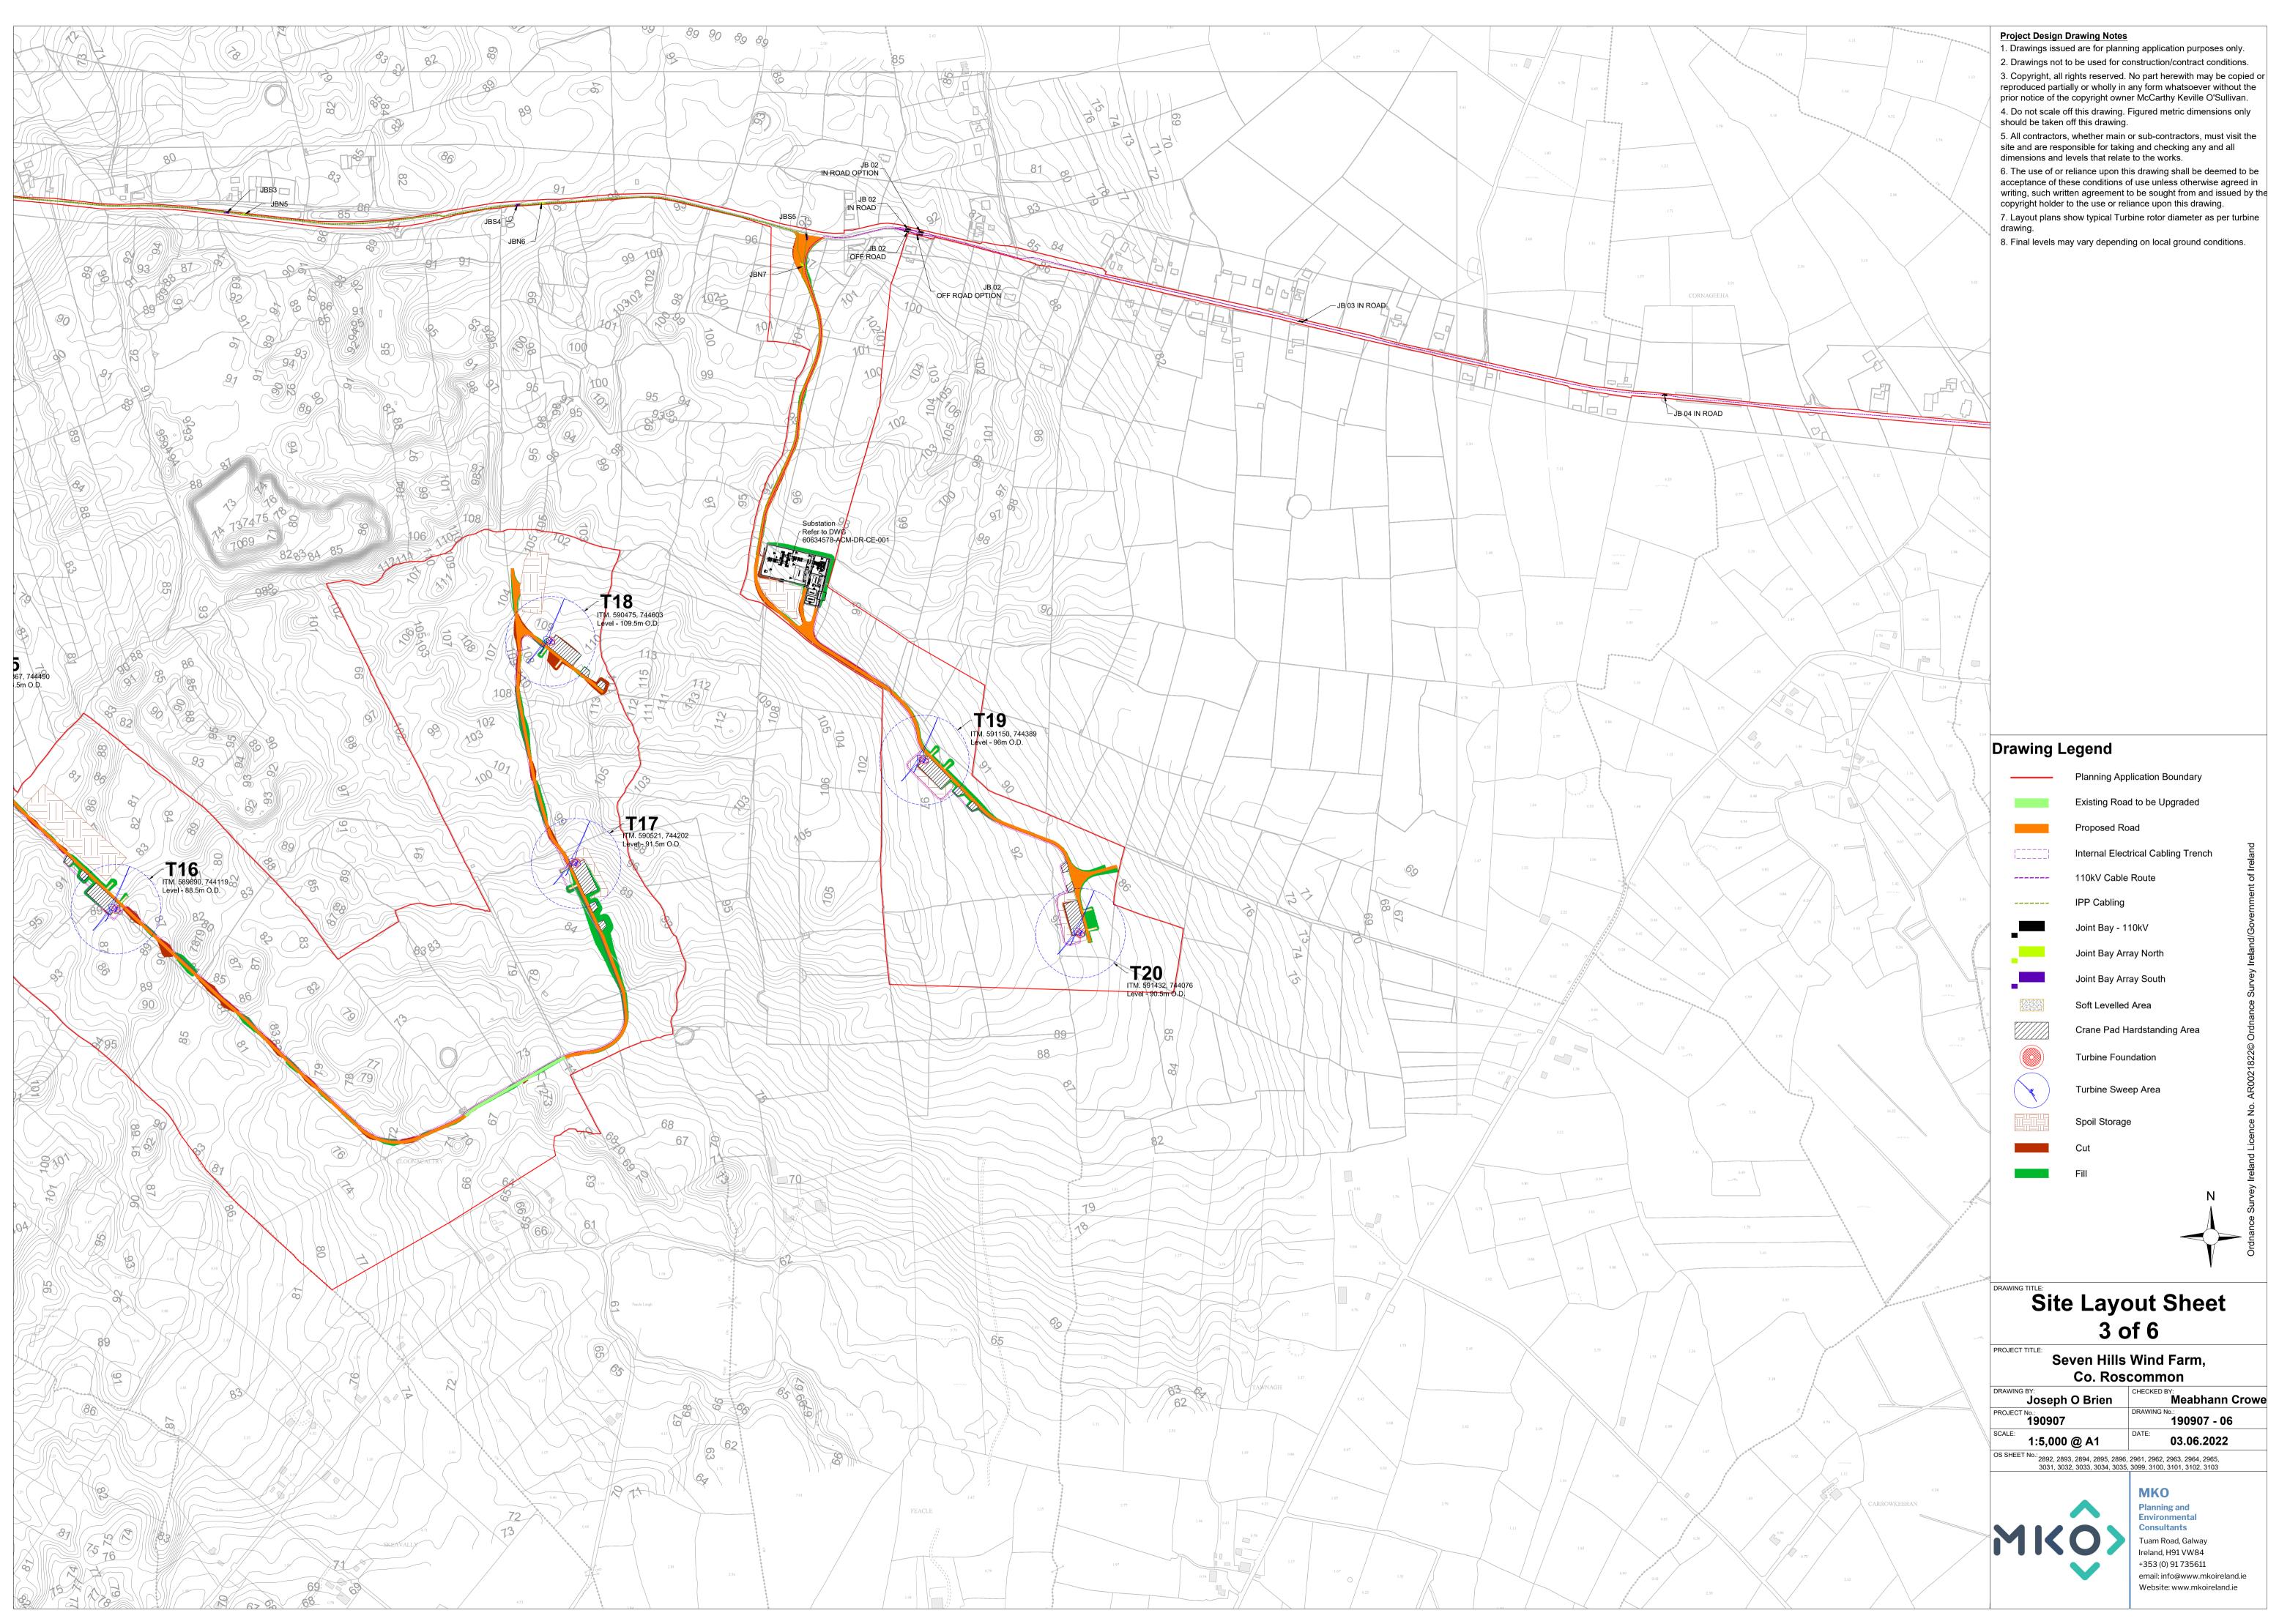
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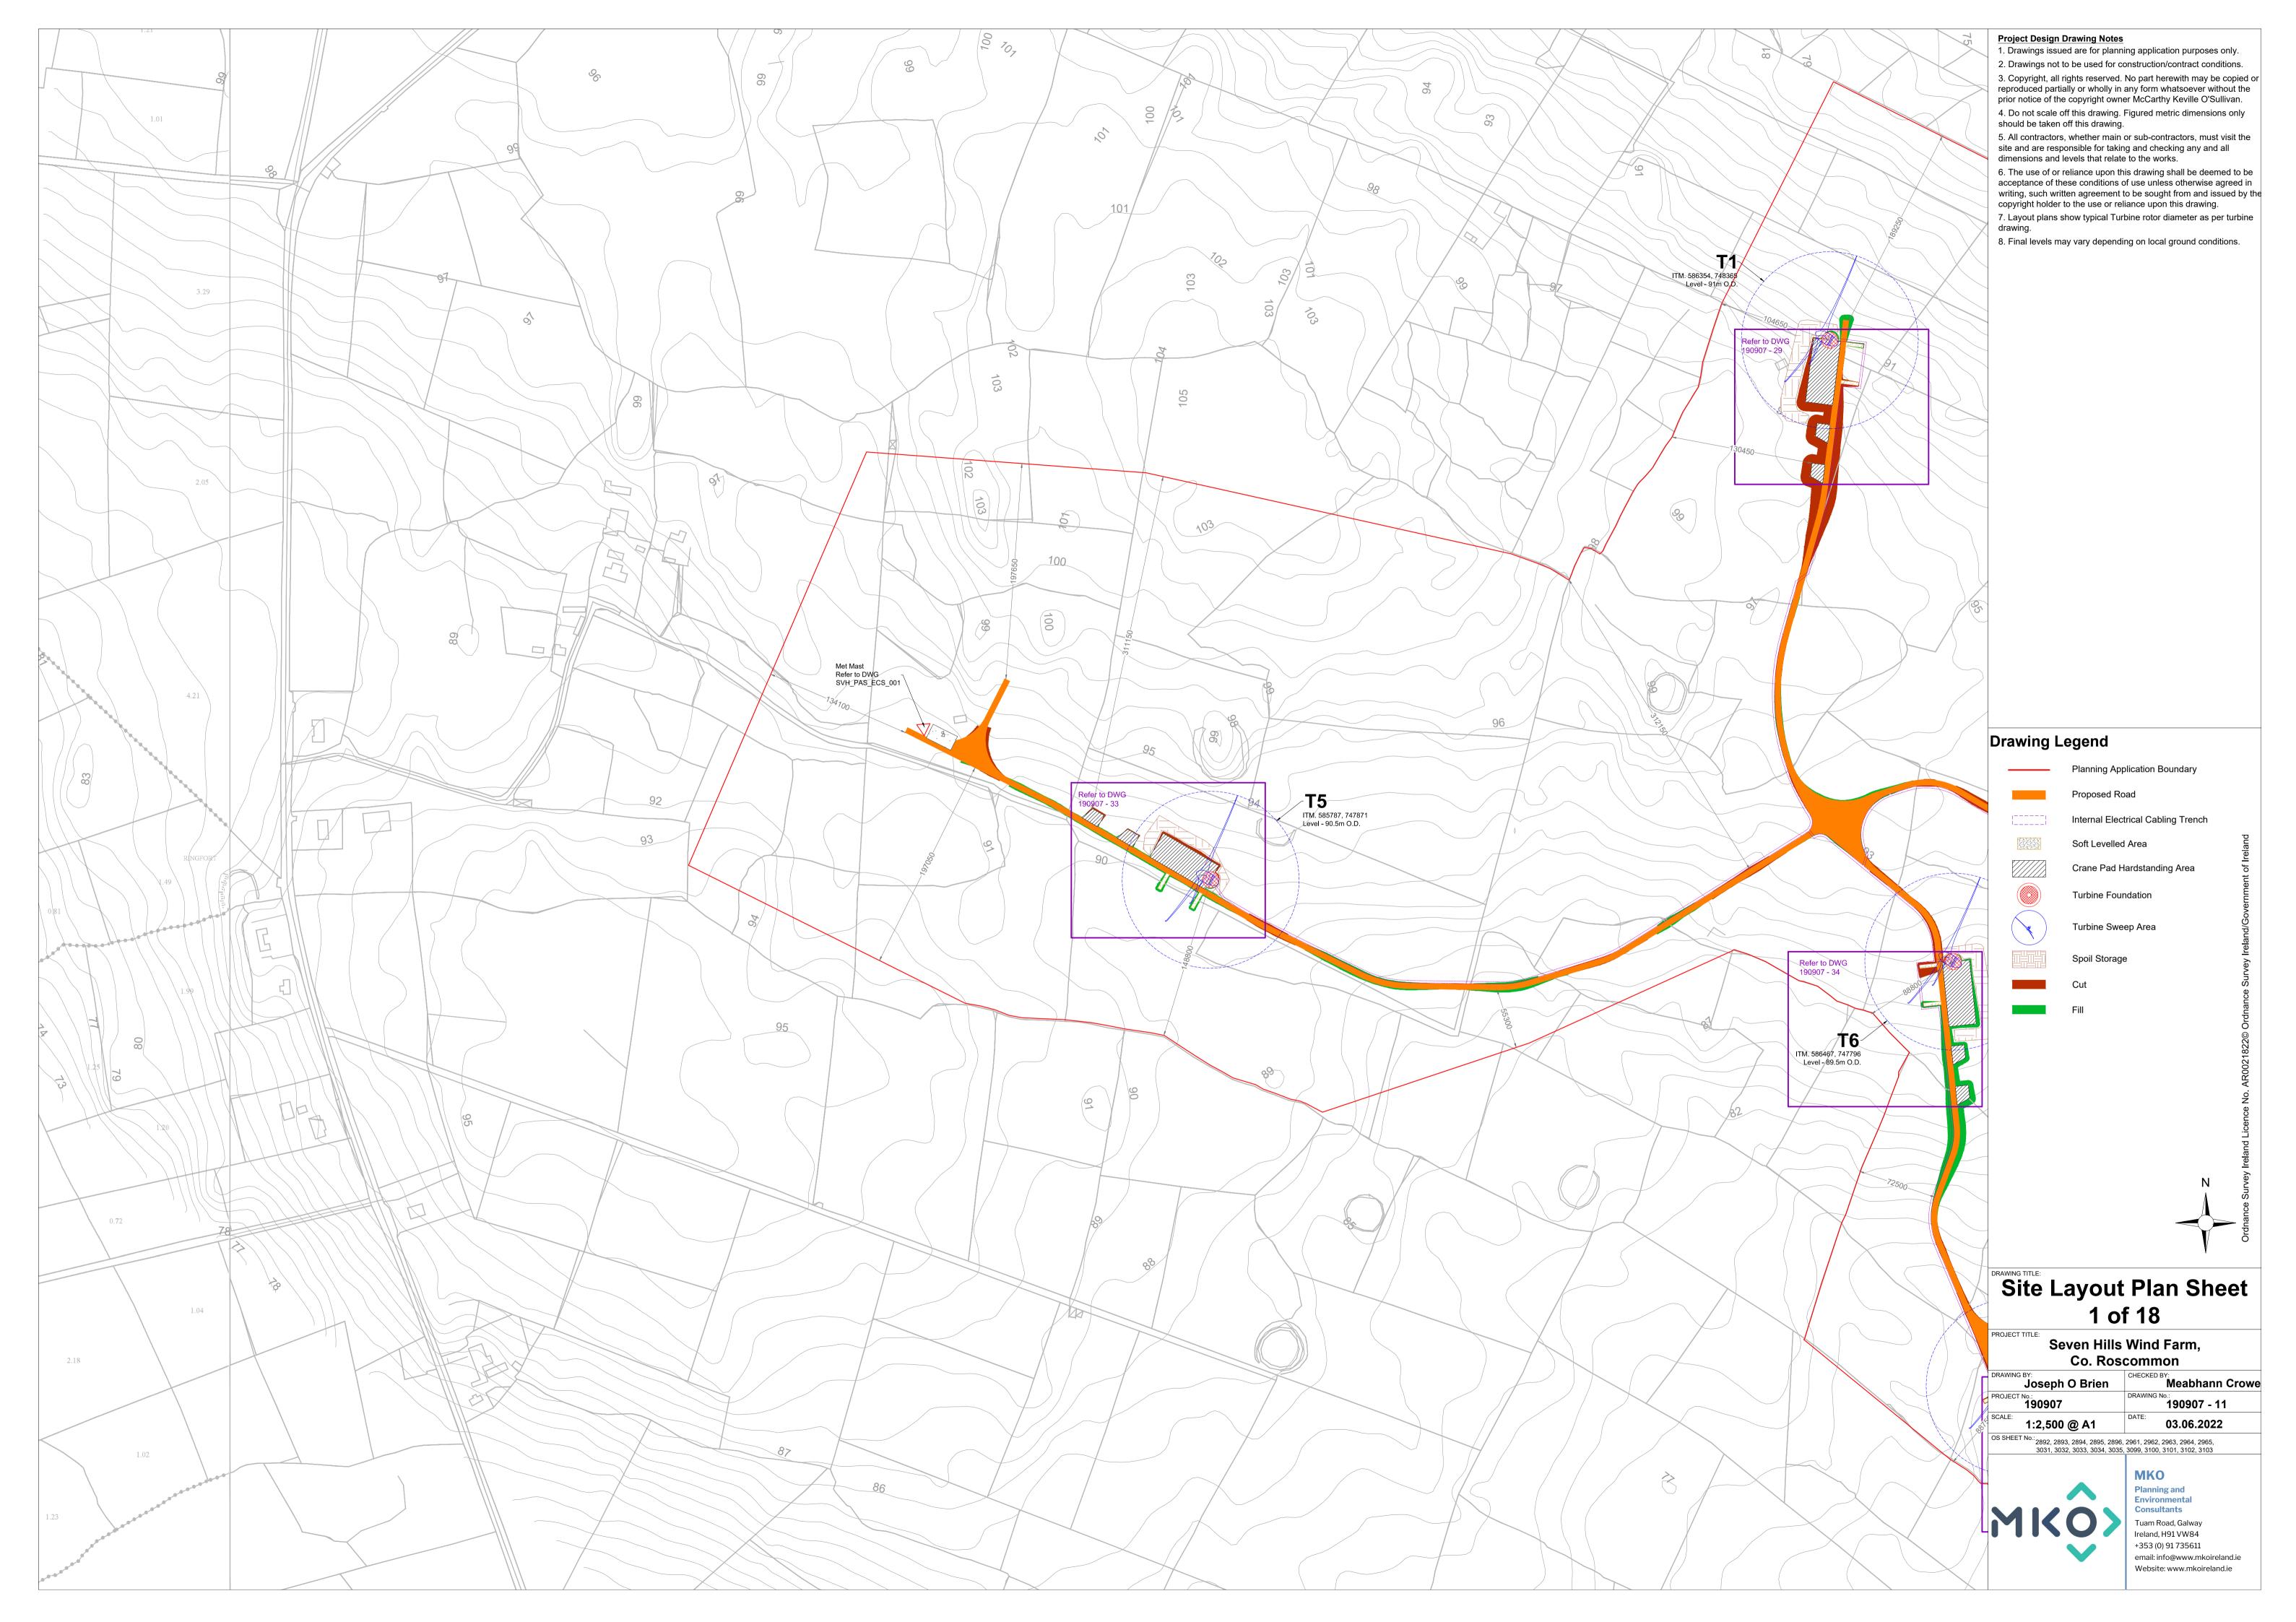
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	Planning Application Boundary	
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	IPP Cabling	rnmer
	N6 HDD	l/Gove
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	Crane Pad Hardstanding Area	R0021
	Turbine Foundation	, No. A
	Turbine Sweep Area	rdnance Survey Ireland Licence No. AR0021822© Ordnance Survey Ireland/Government of Ireland
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Site Layout Key Plan (1:2,500)

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OJECT TITLE:		
Seven Hills Wind Farm,		
Co. Roso	common	
AWING BY: Joseph O Brien	CHECKED BY: Meabhann Crowe	
DJECT No.: 190907	DRAWING No.: 190907 - 10	
^{ALE:} 1:25,000 @ A1	DATE: 03.06.2022	
SHEET No.: 2892, 2893, 2894, 2895, 2896, 3031, 3032, 3033, 3034, 3035,	2961, 2962, 2963, 2964, 2965, 3099, 3100, 3101, 3102, 3103	
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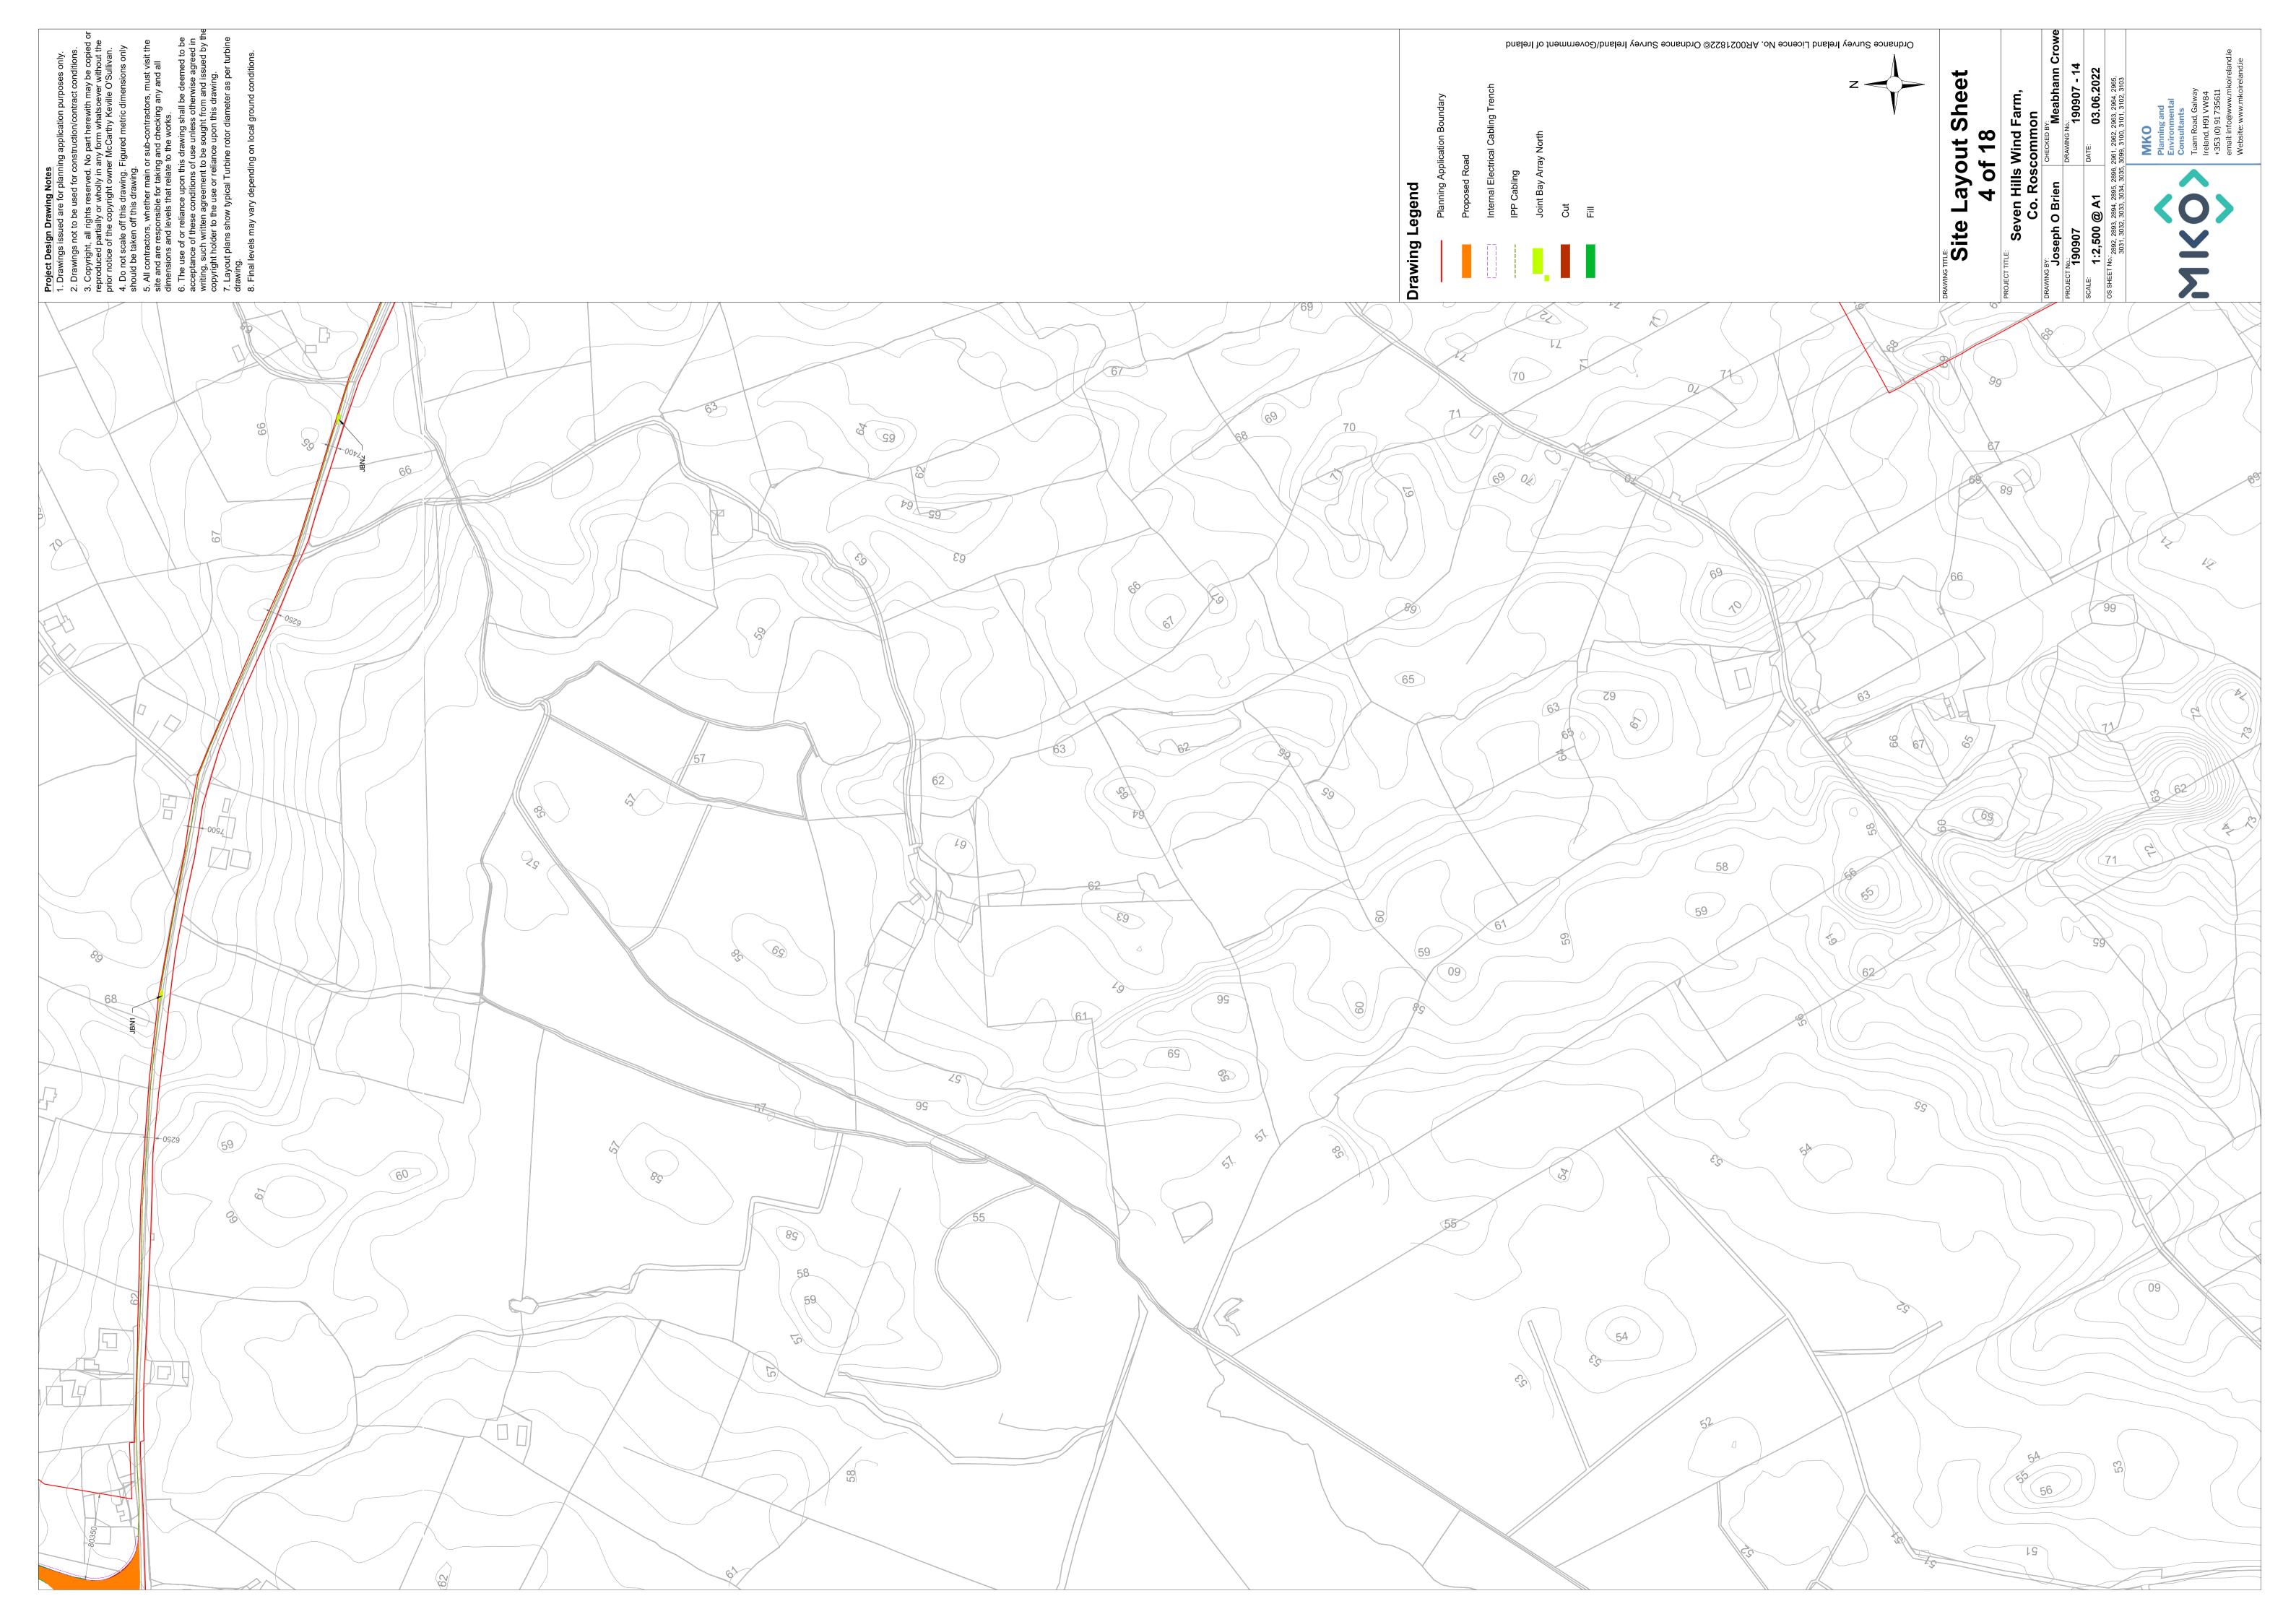
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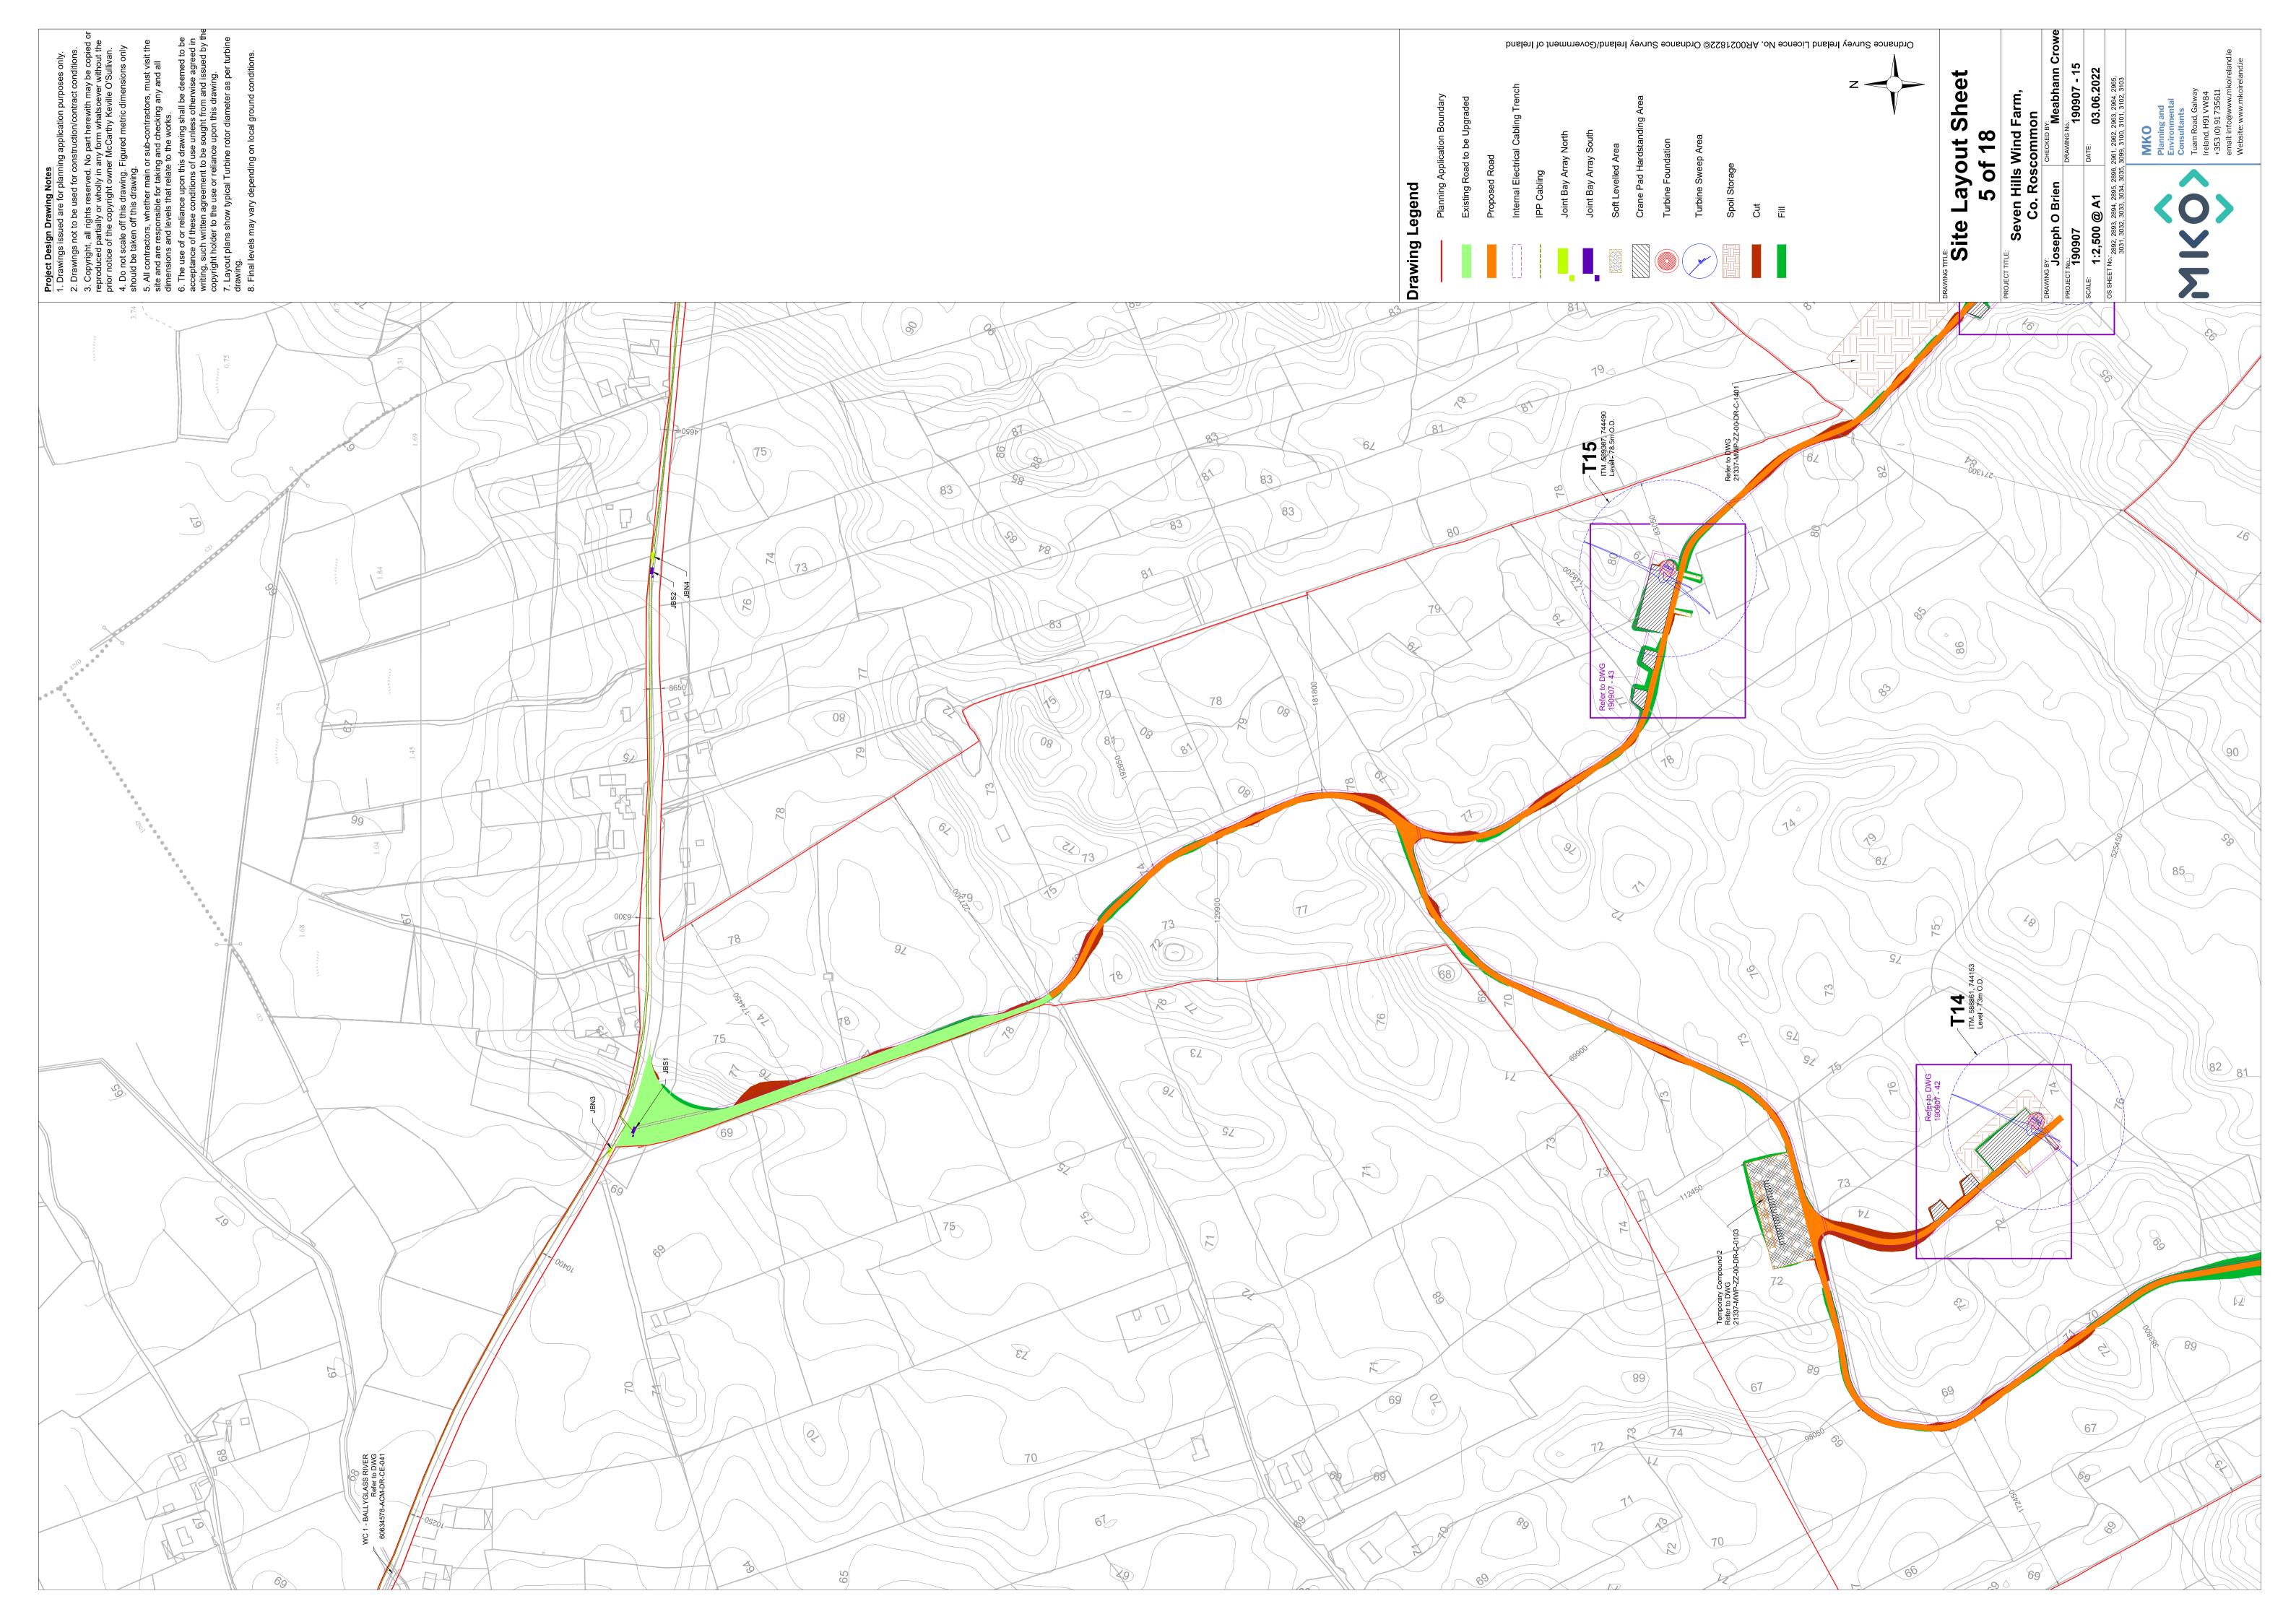
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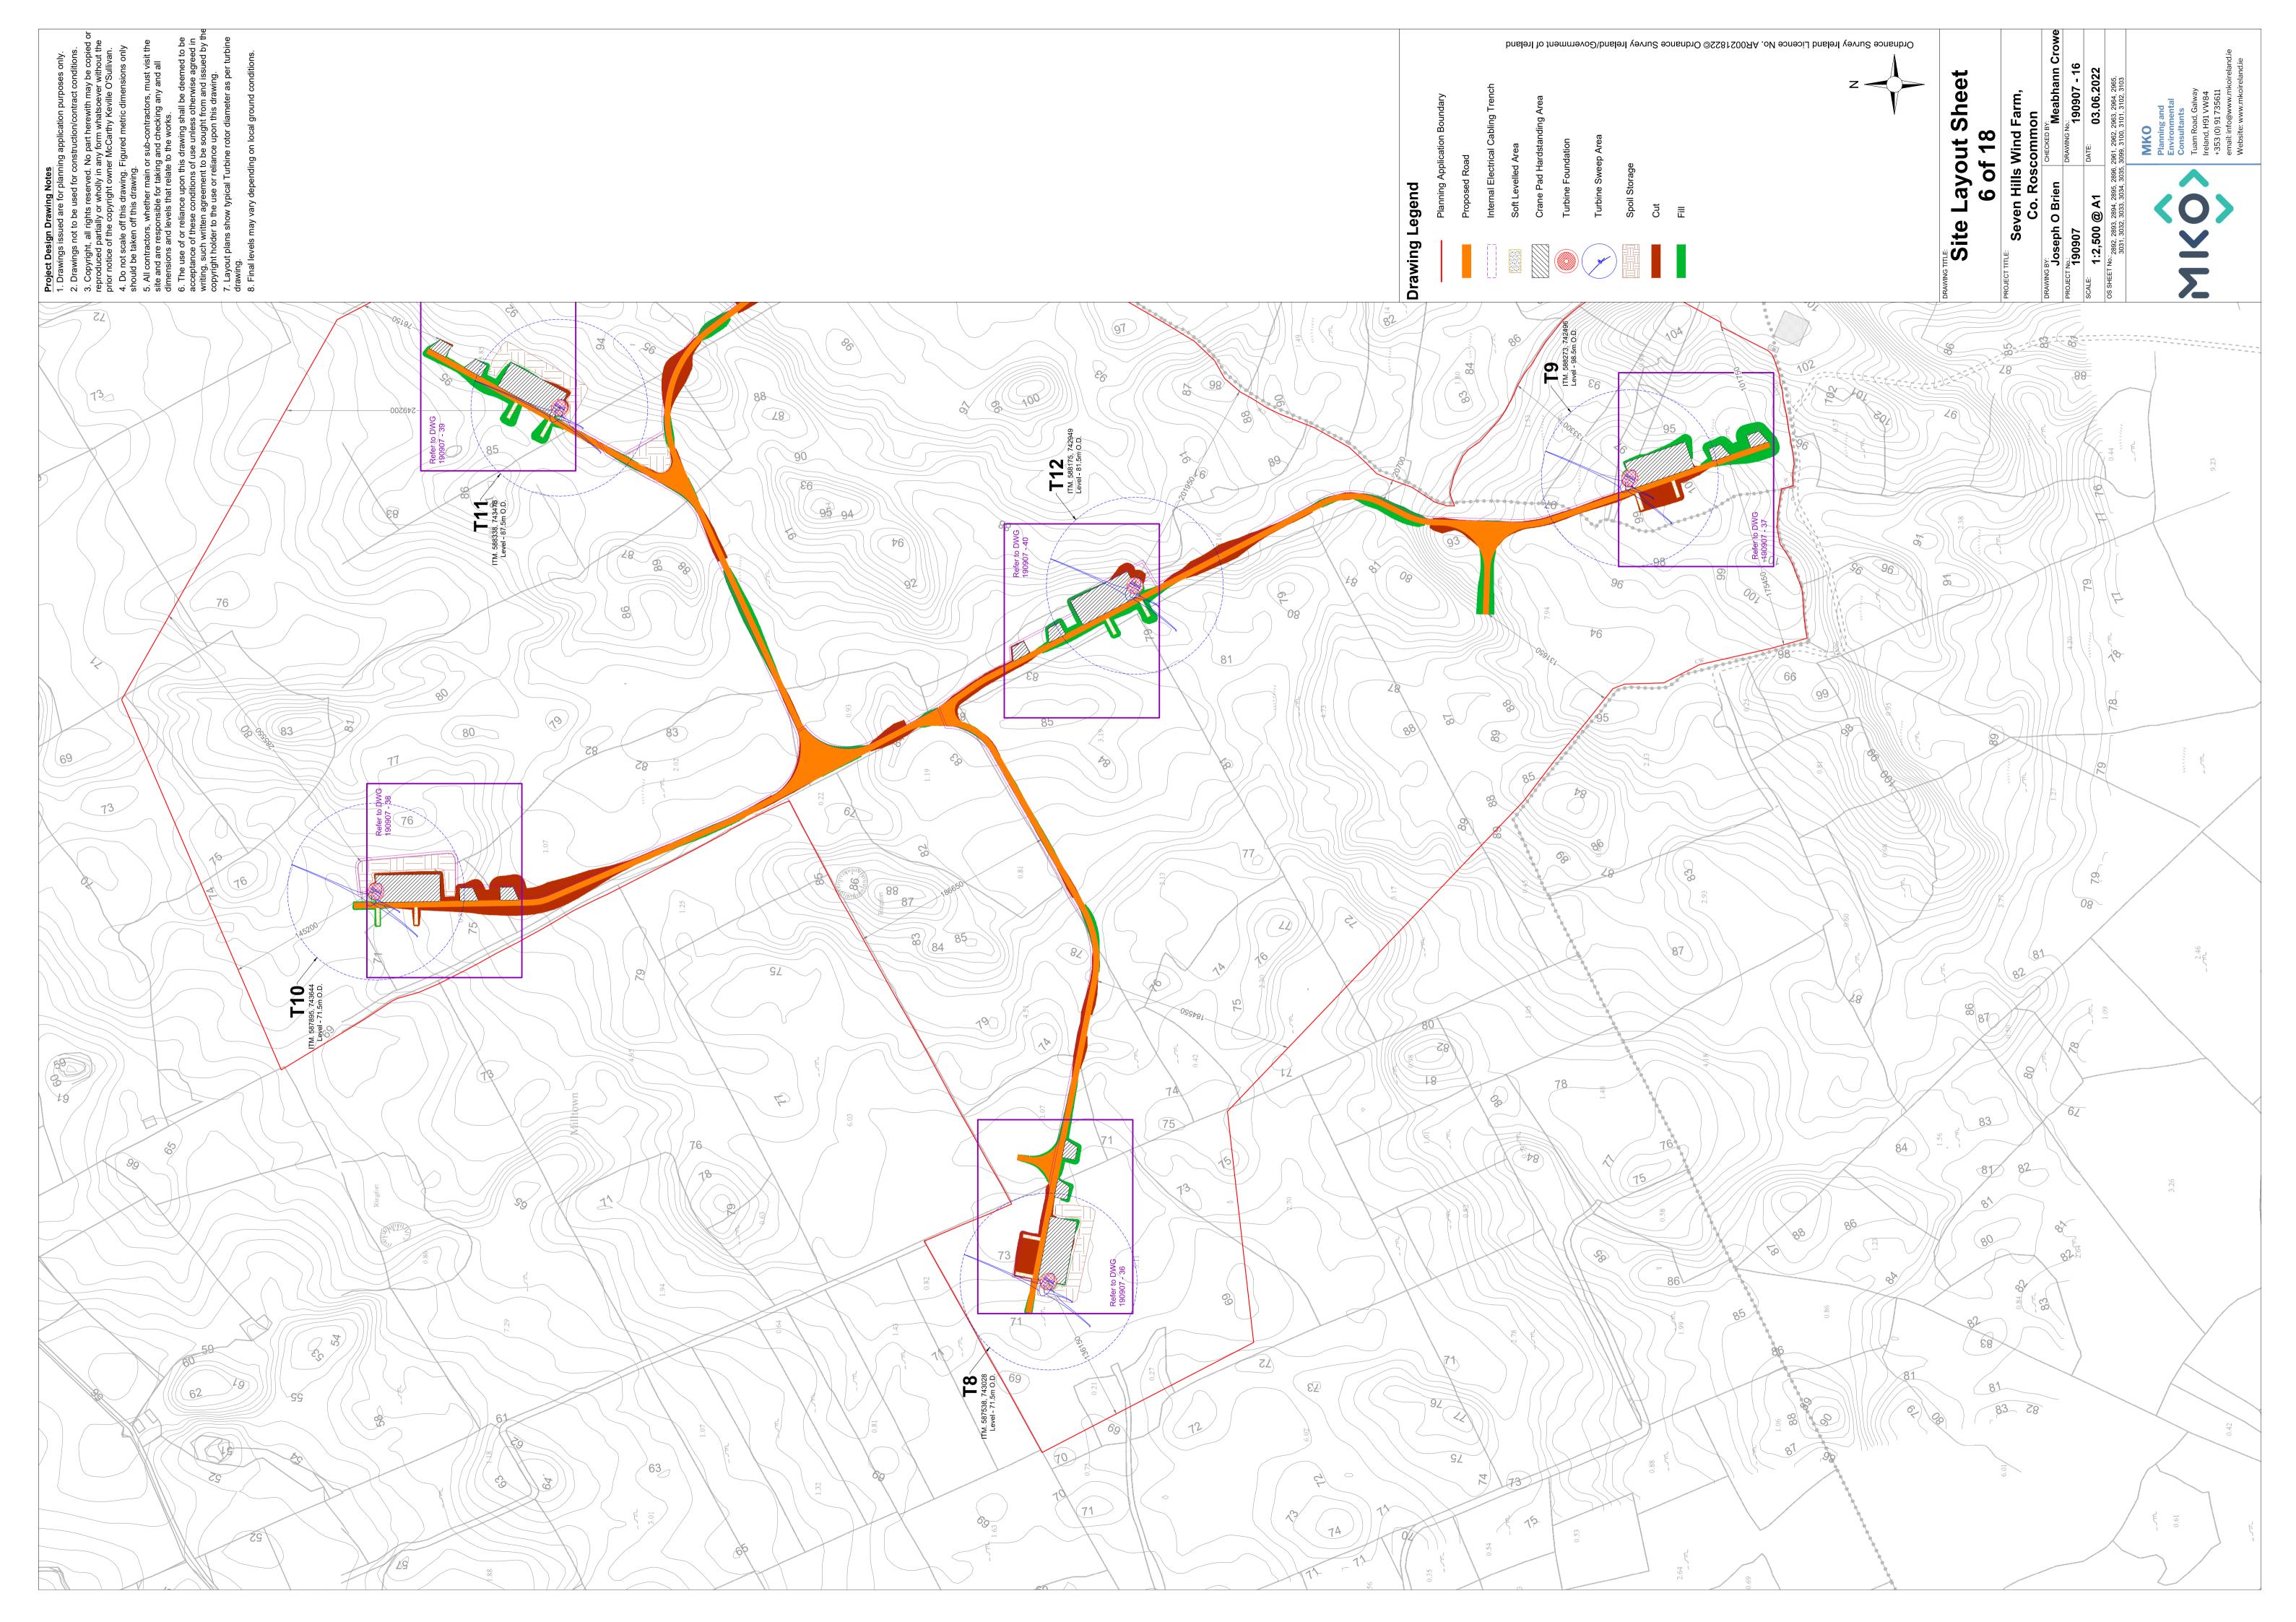







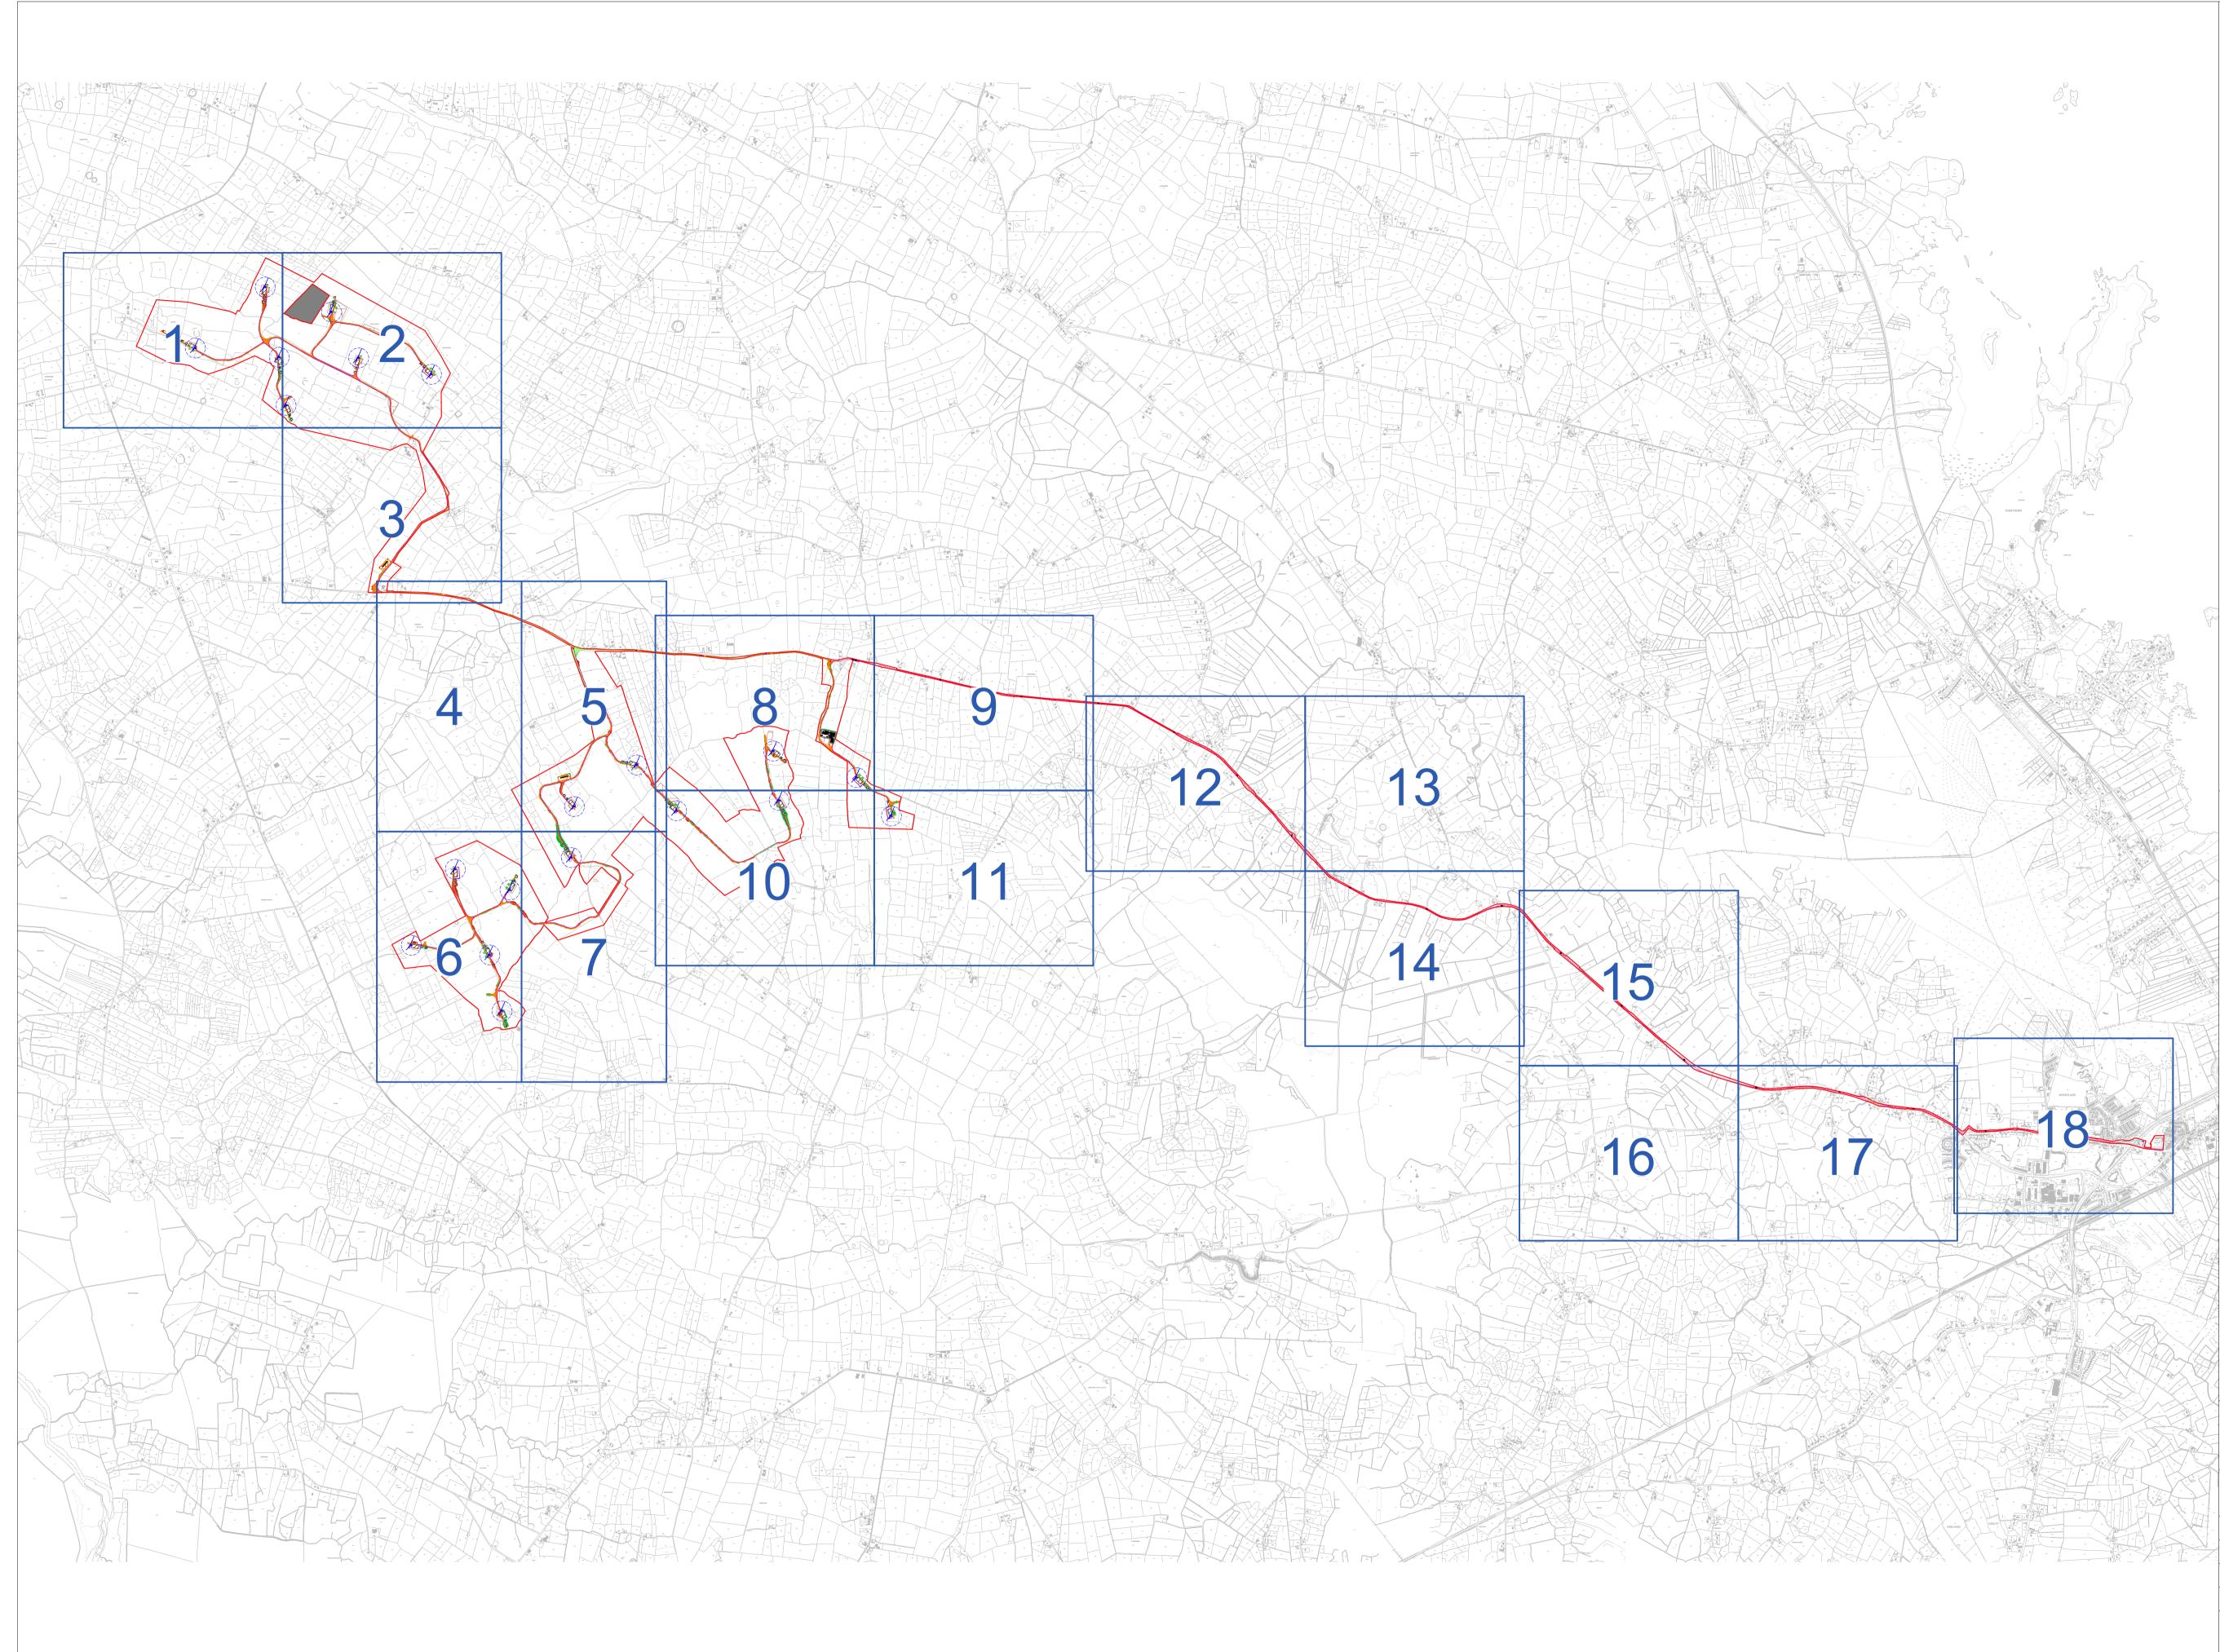







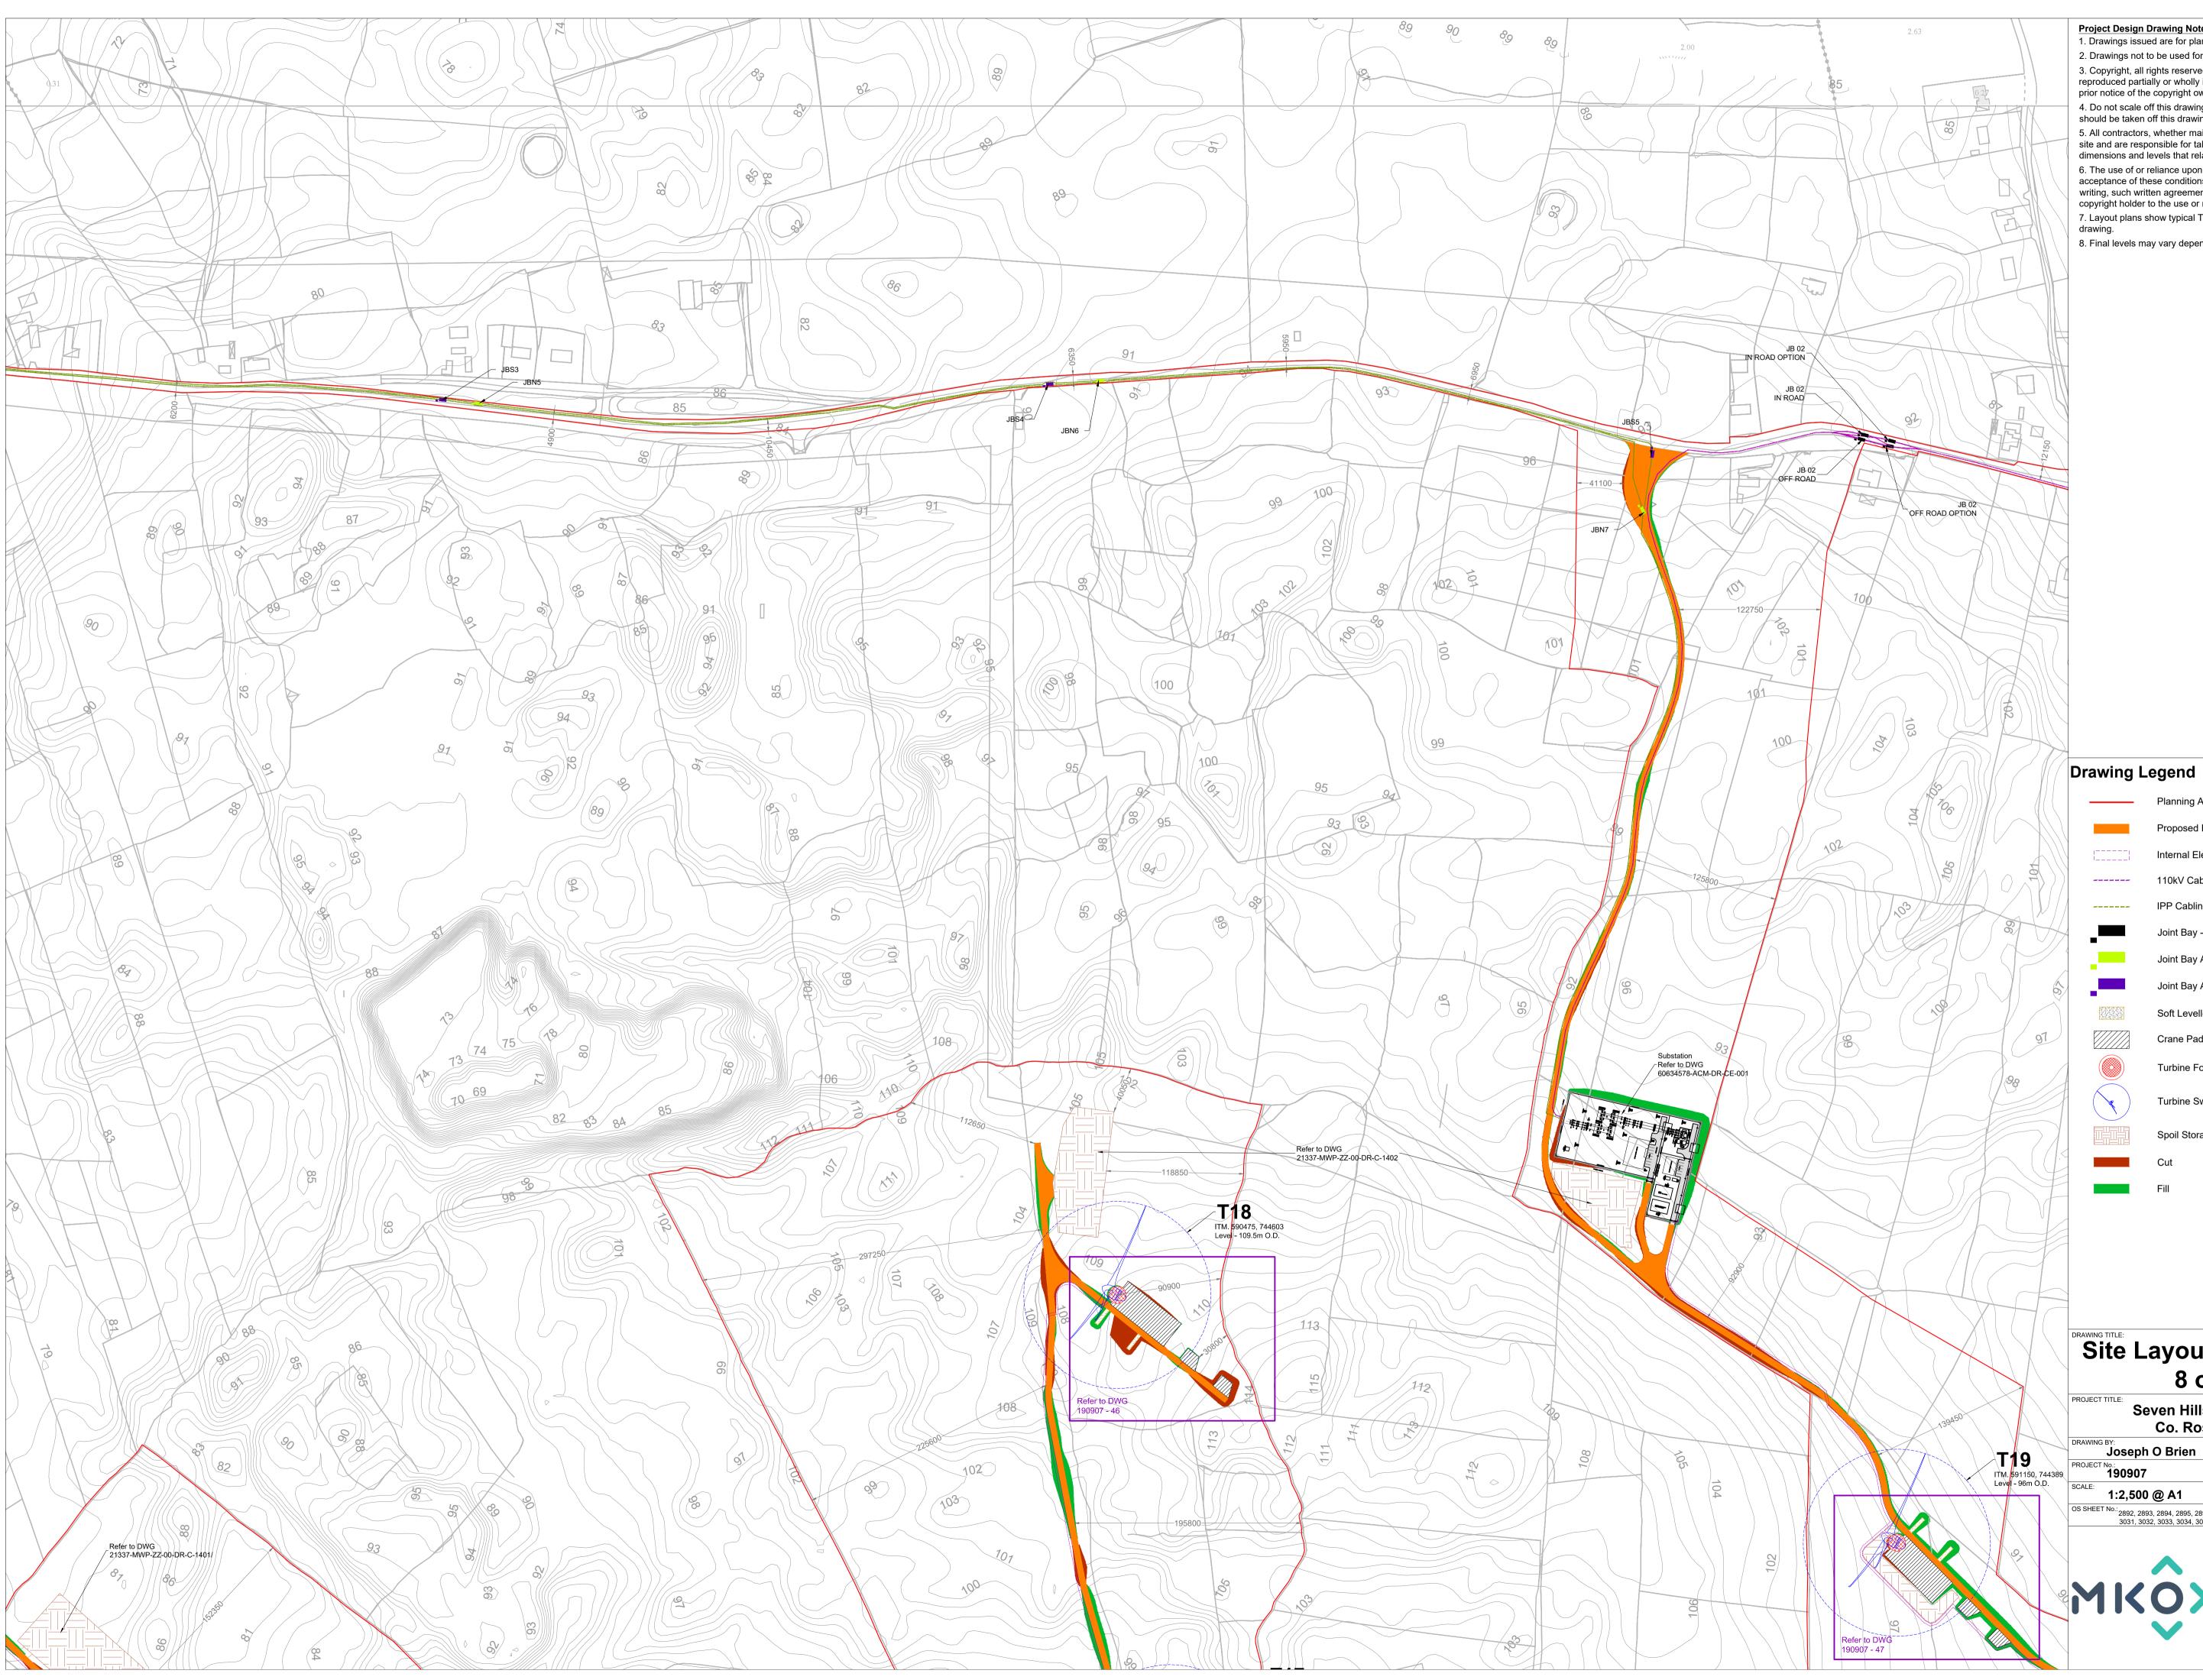

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	Joint Bay Array South	relan
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	Crane Pad Hardstanding Area	ance S
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Site Layout Plan Sheet 8 of 18		
	Wind Farm, common	
Joseph O Brien	CHECKED BY: Meabhann Crowe	
ROJECT No.: 190907	DRAWING No.: 190907 - 18	
^{CALE:} 1:2,500 @ A1	DATE: 03.06.2022	
OS SHEET No.: 2892, 2893, 2894, 2895, 2896, 3031, 3032, 3033, 3034, 3035		
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